REVISIONS:

SHEET TITLE:

THE CITY OF HOMEWOOD HOMEWOOD ATHLETIC COMPLEX PICKLEBALL COURTS HOMEWOOD, AL

Drawing Issue Date: 06/18/25



PREPARED BY:

HNP LANDSCAPE ARCHITECTURE

HNP Project Number : C24057

ELECTRICAL ENGINEER:

JACKSON, RENFRO & ASSOCIATES, INC. **ELECTRICAL ENGINEERING & DESIGN** 31 INVERNESS CENTER PARKWAY | SUITE 300 | BIRMINGHAM, AL 35242 PHIL BLACK, SENIOR PRINCIPAL (205) 995-1078

PROJECT MANGAGER:

THE PENNINGTON GROUP, INC. 2811 CRESCENT AVE. | SUITE 101 | BIRMINGHAM, AL 35209 COREY L. WEAVER, VICE PRESIDENT (OWNER/ SECRETARY) (205) 802-1156

SHEET TITLE	SHEET NUMBER
COVER SHEET LAYOUT & GRADING / DRAINAGE PLAN FURNITURE PLAN & COURT ENLARGEMENTS DETAILS	L0.0 L1.0 L1.1 L2.0
ELECTRICAL LEGEND & NOTES ELECTRICAL DIAGRAMS, DETAILS & SCHEDULES ELECTRICAL DETAILS SITE ELECTRICAL PLANS SITE PHOTOMETRIC PLAN	E0.1 E0.2 E0.3 E1.0 E1.1



PROJECT LOCATION MAP

 SHOULD ANY MUD, SILT, OR DEBRIS BE WASHED ON OR IN TO ANY ADJACENT PROPERTY, STREET OR STORM SEWER. CONTRACTOR IS TO REMOVE SUCH AT ONCE.

4. ALL CONSTRUCTION MATERIALS STORED ON SITE THAT MAY CONTAIN POLLUTANTS, SHALL BE STORED IN COVERED AREAS THAT WILL NOT ALLOW POLLUTANTS TO ESCAPE. ALL SUCH MATERIAL SHALL BE REMOVED FROM SITE AT THE END OF CONSTRUCTION AND BE DISPOSED OF ACCORDING TO APPLICABLE ORDINANCES.

5. MAXIMUM CROSS SLOPE ON ANY WALK/ PLAZA IS 2.0%; RUNNING SLOPE MAX. 5%.

6. CONTRACTOR RESPONSIBLE TO FINE GRADE SUCH THAT POSITIVE DRAINAGE IS MAINTAINED ON ALL SURFACES AT ALL TIMES

CONTRACTOR SHALL MAINTAIN "BEST MANAGEMENT PRACTICES" AND ADHERE TO RECOMMENDATIONS AS OUTLINED IN U.S. DEPARTMENT OR TRANSPORTATION REPORT NO. FHWA-FL-94-005 "BEST MANAGEMENT PRACTICES FOR EROSION AND SEDIMENT CONTROL".

PLANTING NOTES


1'-6" TYP.

- 1. CONTRACTOR TO VERIFY ALL PLANT MATERIAL QUANTITIES AND PLANTING AREA DIMENSIONS PRIOR TO BEGINNING PLANTING. PROVIDE QUANTITIES AS REQUIRED TO MEET DRAWN DESIGN INTENT. IF DISCREPANCIES BETWEEN PLANS, DETAILS, AND SCHEDULE EXIST, CONTRACTOR TO NOTIFY LANDSCAPE ARCHITECT IMMEDIATELY. SEE PLANTING NOTES.
- 2. INTENT OF LANDSCAPE PLANS IS TO REQUIRE CONTRACTOR TO PROVIDE AND INSTALL PLANTING, SEED, SOD, OR MULCH ON ALL DISTURBED AREAS. IF DISTURBANCE AND/ OR INTENT IS UNCLEAR, VERIFY WITH LANDSCAPE ARCHITECT PRIOR TO BIDDING. DUE TO MODIFICATIONS MADE DURING CONSTRUCTION, SITE CONDITIONS MAY VARY FROM THOSE SHOWN. PRIOR TO COMMENCING WORK, CONTRACTOR TO VERIFY ALL SUCH CONDITIONS TO HIS SATISFACTION. NO CHANGE IN CONTRACT PRICE WILL BE GRANTED FOR FAILUR TO OBSERVE EITHER OF THESE REQUIREMENTS.
- LOCATION OF ALL UTILITIES PRIOR TO COMMENCING ANY CONSTRUCTION.

 DEMOVE PASS MATERIAL POCKS DEPRIS ETC. FROM BLANTING AREAS RECORE

3. THE CONTRACTOR SHALL, FOR HIS OWN PROTECTION, VERIFY THE PRESENCE AND

- 4. REMOVE BASE MATERIAL, ROCKS, DEBRIS, ETC. FROM PLANTING AREAS BEFORE PLANTING OPERATIONS BEGIN.
- CLEANUP AT THE END OF THE PROJECT, THE CONTRACTOR SHALL PRESSURE WASH ALL CONCRETE SURFACE (I.E., CURB AND GUTTERS, SIDEWALKS, DRIVES, STORM SEWER BOXES, BRICK PAVERS, EXISTING BUILDING BRICK AND STONE, SPECIFICALLY EXISTING CONCRETE ABUTTING REQUIRED CONCRETE SURFACES WITHIN THE PROJECT AND ALL ADJACENT AREA(S) TO ELIMINATE STAINING FROM EARTHEN MATERIAL, CONSTRUCTION EQUIPMENT, OILS, PAINTS, ETC. THIS WORK SHALL BE CONSIDERED INCIDENTAL TO THE CONTRACT AT NO ADDITIONAL COSTS TO THE OWNER.

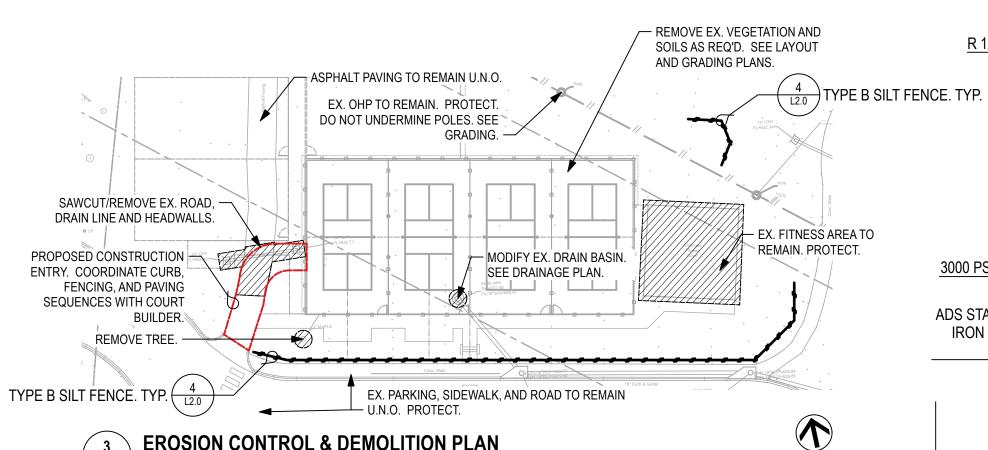

APPROVAL OF THE LANDSCAPE ARCHITECT ONLY.

TYPE B SILT I
CHECK DIMENSIONS GIVEN ARE FOR FIELD VERIFICATION OF LAYOUT. NOTIFY
LANDSCAPE ARCHITECT OF ANY DISCREPANCIES.

9. ALL UTILITY ACCESS POINTS (VALVE BOXES, METER COVERS, ETC.) TO BE RAISED OR LOWERED TO MATCH FINISHED GRADE. REUSE EXISTING COVERS OR SUPPLY NEW COVERS AS REQUIRED.

7. ANY VARIATION FROM DRAWINGS OR SUBSTITUTIONS IN MATERIALS WITH THE

1. ALL WORK WILL CONFORM TO ALL LOCAL, COUNTY AND STATE CODES AND

LOCATE UTILITIES PRIOR TO ALL EXCAVATIONS, INCLUDING TREE PITS.

2. THE CONTRACTOR SHALL, FOR HIS OWN PROTECTION, VERIFY THE PRESENCE

4. LAYOUT WORK AND VERIFY ALL DIMENSIONS PRIOR TO ACTUAL CONSTRUCTION.

WORK. CONTRACTOR SHALL BE RESPONSIBLE FOR STAKING SITE LAYOUT, GRADES, AND LIMIT OF WORK. THE WORK MUST BE STAKED BY A LICENSED

REGULATIONS. OBTAIN ALL CONSTRUCTIONS, LICENSES, ETC. REQUIRED FOR

AND LOCATION OF ALL UTILITIES PRIOR TO COMMENCING ANY CONSTRUCTION.

NOTIFY LANDSCAPE ARCHITECT OF ANY DISCREPANCIES BEFORE CONTINUING

SURVEYOR. DIMENSIONS ARE GIVEN FROM BACK OF CURB, FACE OF STRUCTURE.

CONDUCT ALL OPERATIONS TO AVOID DAMAGE TO OR DISTURBANCE OF EXISTING

CLEAN-UP, REMOVE AND PROPERLY DISPOSE OF ALL DEBRIS, WASTE AND EXCESS

CONSTRUCTION MATERIALS FOLLOWING COMPLETION AND LEAVE NEAT, CLEAN

LAYOUT & MATERIALS NOTES

OR THE IDENTIFIED CENTERLINES.

READY FOR OWNER'S USE.

LAYOUT PLAN

、∟1.0 / Scale: 1" = 20'-0"


VEGETATION AND STRUCTURES TO REMAIN.

EXECUTION OF WORK.

10. CLEANOUTS/CLEANOUT COVERS IN PAVING SHALL BE HEAVY DUTY, ADJUSTABLE TYPE WITH SCORIATED BRONZE METAL COVERS WITH VANDAL-PROOF SCREWS, AND COATED CAST IRON BODY. ZURN ZB1400-HD-VP OR APPROVED SUBSTITUTE. SIZE AS REQ'D FOR ACCESS AND SHALL BE MIN. 4" AND MAX. 8" UNLESS APPROVED BY LANDSCAPE ARCHITECT. COVERS/FRAMES SHALL BE SET PERFECTLY FLUSH IN SURROUNDING PAVING.

11. REMOVE ALL CONSTRUCTION DEBRIS AND BASE MATERIAL FROM PLANTING BEDS ISLANDS, ETC. AND LEAVE READY FOR TOPSOIL PLACEMENT AND PLANTING. CONFIRM ADEQUATE DRAINAGE IN ALL PLANTING AREAS. NOTIFY LANDSCAPE ARCHITECT OF UNSATISFACTORY CONDITIONS.

12. CONSTRUCTION SAFETY - THE PRESENCE OF THE LANDSCAPE ARCHITECT, ITS EMPLOYEES, OR CONSULTANTS AT THE PROJECT SITE SHALL NOT BE DEEMED AN ASSUMPTION BY THE LANDSCAPE ARCHITECT OF ANY OBLIGATIONS, DUTIES, OR RESPONSIBILITIES FOR SAFETY, INCLUDING BUT NOT LIMITED TO CONSTRUCTION MEANS, METHODS, SEQUENCES, TECHNIQUES, OR PROCEDURES NECESSARY FOR PERFORMING, SUPERINTENDING, OR COORDINATING THE WORK OF THE PROJECT IN ACCORDANCE WITH THE CONSTRUCTION DOCUMENTS OR REGULATORY HEALTH OR SAFETY REQUIREMENTS, IF ANY. THE LANDSCAPE ARCHITECT, ITS EMPLOYEES, AND CONSULTANTS HAVE NO AUTHORITY TO EXERCISE ANY CONTROL OVER ANY CONSTRUCTION CONTRACTOR, ITS EMPLOYEES, OR SUBCONTRACTORS IN CONNECTION WITH THEIR WORK OR HEALTH AND SAFETY PROGRAMS AND PROCEDURES.

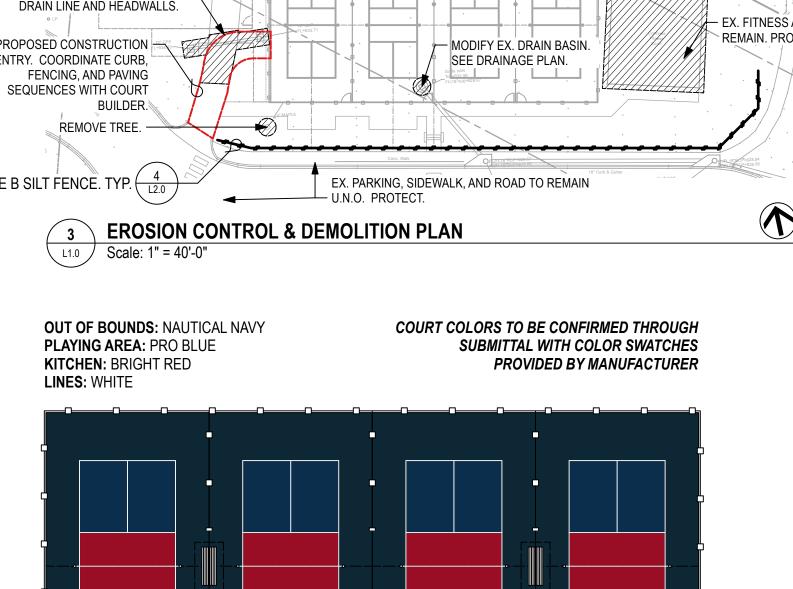

FLUSH FINISH GRADE POSITIVE FLOW TO DRAIN. TYP.: 3000 PSI CONCRETE SURROUND ADS STANDARD ROUND DUCTILE IRON FRAME AND GRATE. SIZE PER PLAN. ADS NYLOPLAST DRAIN BASIN. MULTIPLE INVERTS IF APPLICABLE. SEE PLAN. ADS NYLOPLAST ADAPTER ANGLE AND SIZE PER ADS N-12 DRAIN PLANS, FIELD VERIFY. LINE. SEE PLAN. 4" MIN. COMPACTED #57 LIMESTONE BACKFILL COMPACTED SUBGRADE **SECTION VIEW**

SEE PLAN

R 1/2". TYP.

TOOLED JOINT, TYP.

PER PLAN.

GRADING / DRAINAGE PLAN

Scale: 1" = 20'-0"


3000 PSI CONCRETE SURROUND

ADS STANDARD ROUND DUCTILE

IRON FRAME AND GRATE. SIZE


PLAN VIEW

5 DRAIN BASIN
L1.0 Scale: 1 1/2" = 1'-0"

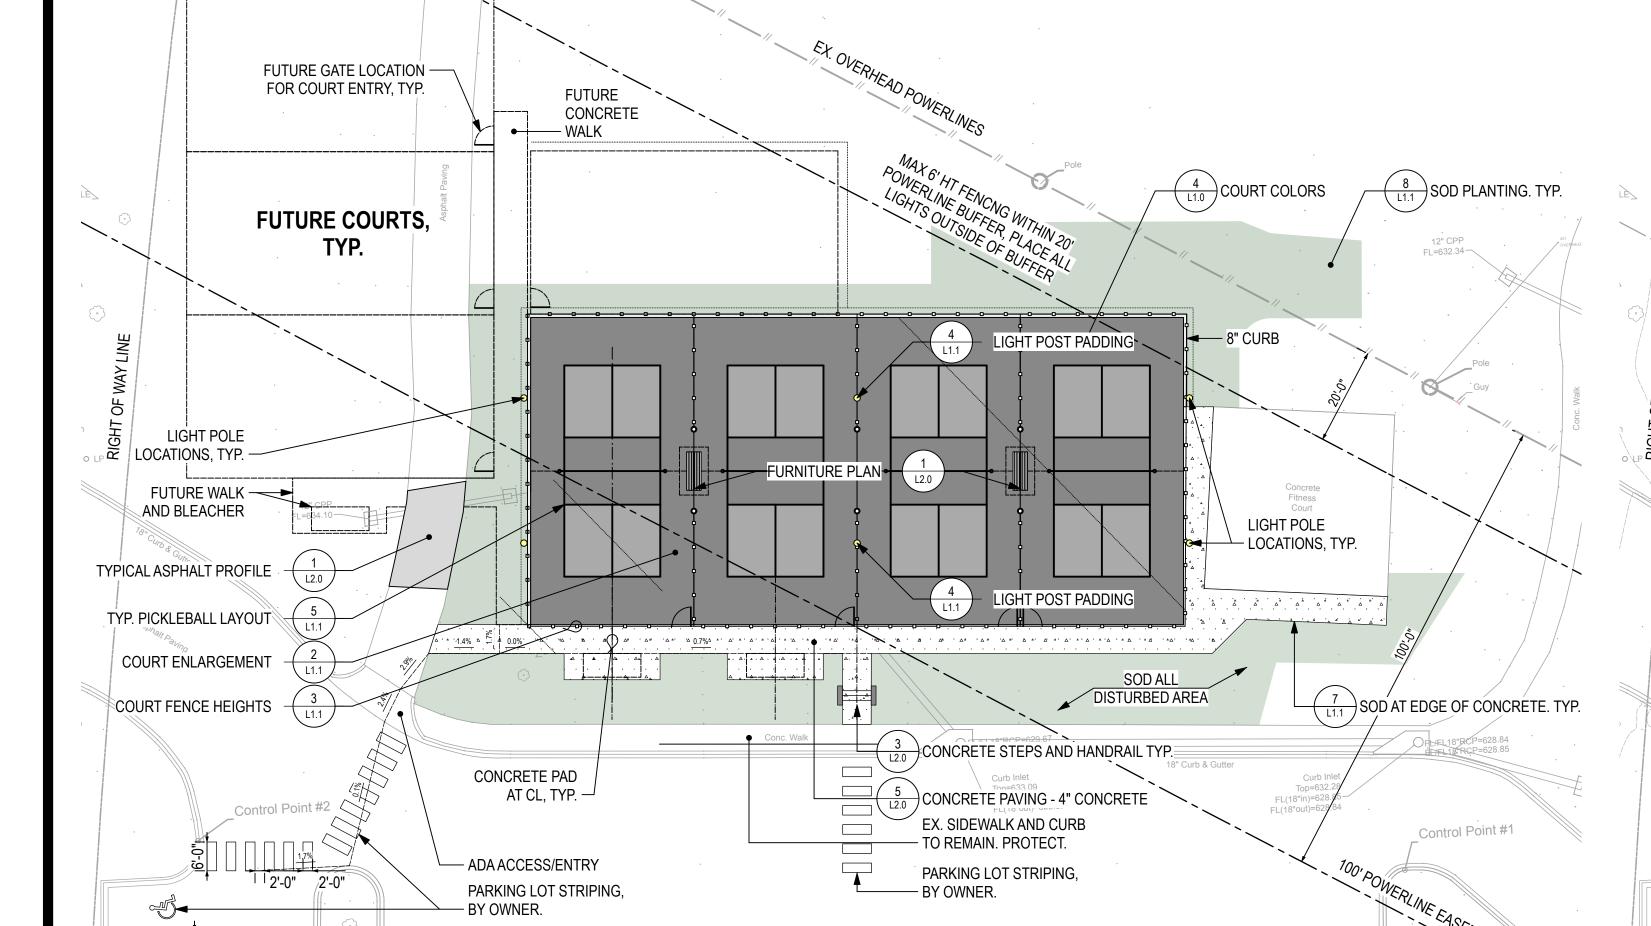

EXISTING PARKING LO

COURT COLORS

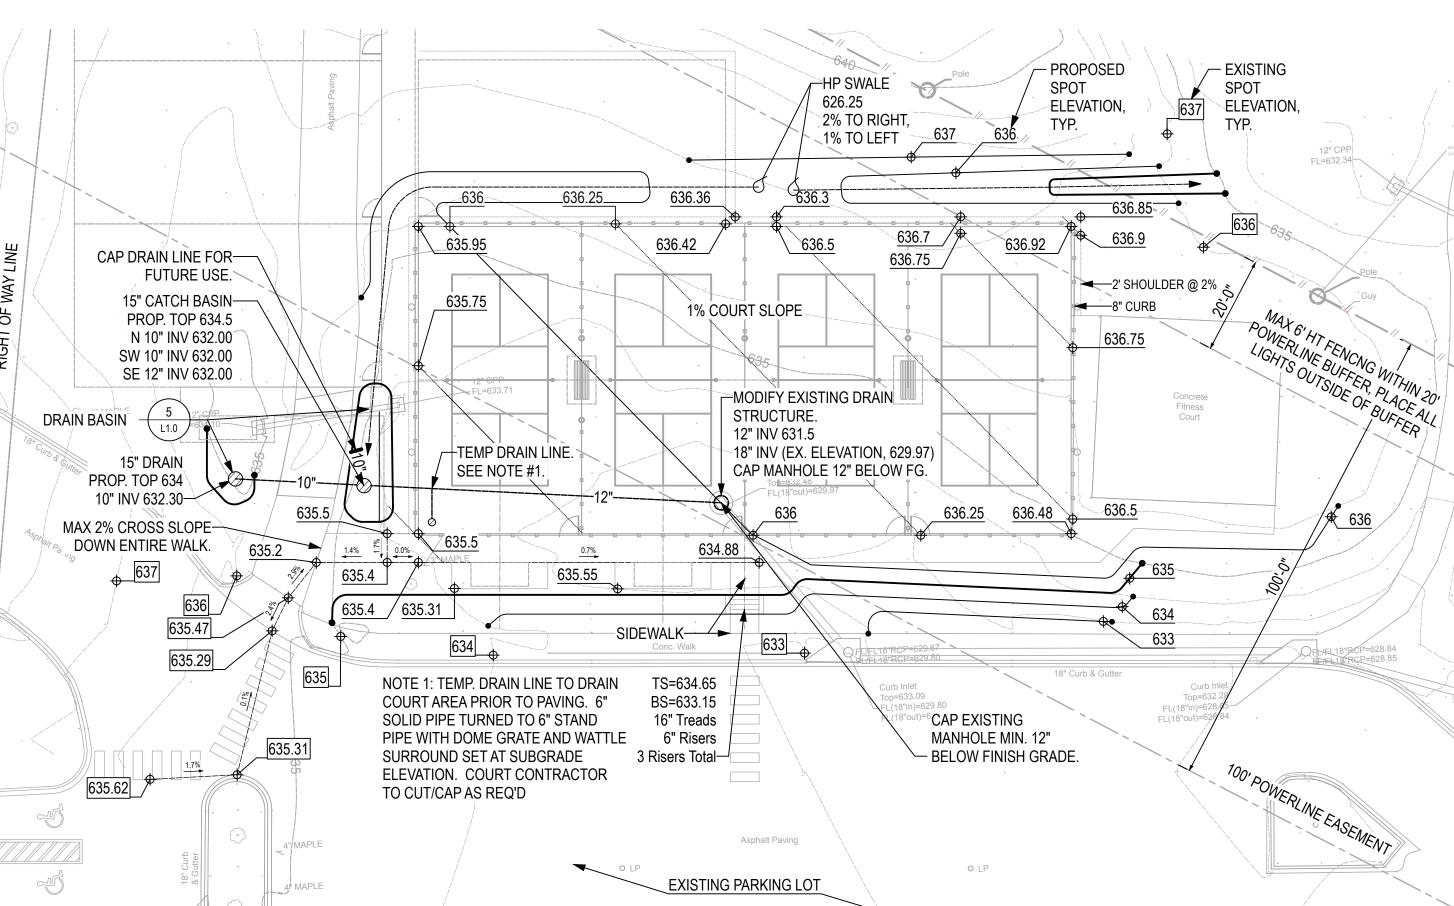

HNP

LANDSCAPE ARCHITECTURE

1914 28TH AVE SOUTH BIRMINGHAM, AL 35209

> 205-870-9936 HNPSITEPLAN.COM

City of Homewood

COMPLEX PICKLEBALL COURTS
Homewood, AL

B

0

STATE OF THE OWNER OWNER OF THE OWNER OWN

REVISIONS:

ISSUED: 06/18/25 BID SET

SHEET TITLE:
DEMO, LAYOUT,
GRADING, DRAINAGE
PLANS

DRAWN: WL CHECKED: SMH
SHEET

L1.0

DCM#: 2025XXX PROJECT#: C24057


PIC

0

TILLED SUBSOIL

8 SOD PLANTING. TYP. L1.1 / Scale: 1" = 1'-0"

EXISTING SUBGRADE

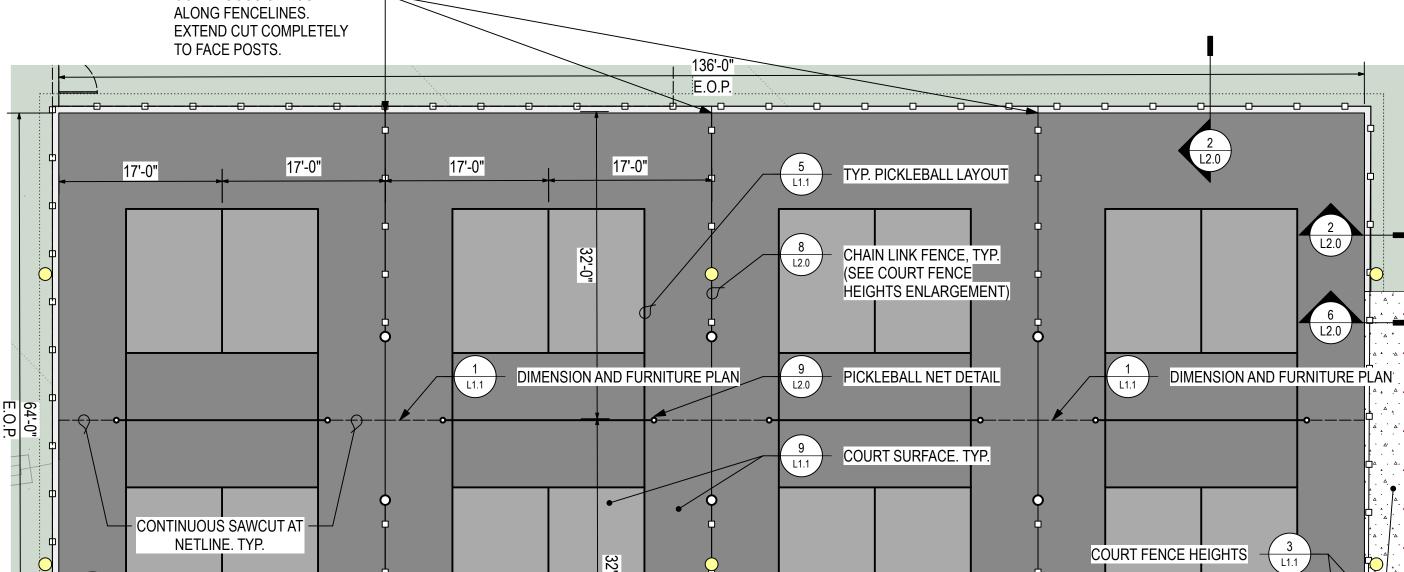

EDGE OF CONCRETE

SOD AT EDGE OF CONCRETE. TYP.

REVISIONS:


ISSUED: 06/18/25 BID SET

SHEET TITLE: **FURNITURE PLAN & ENLARGEMENTS**

DRAWN: WL CHECKED: SMH

SHEET



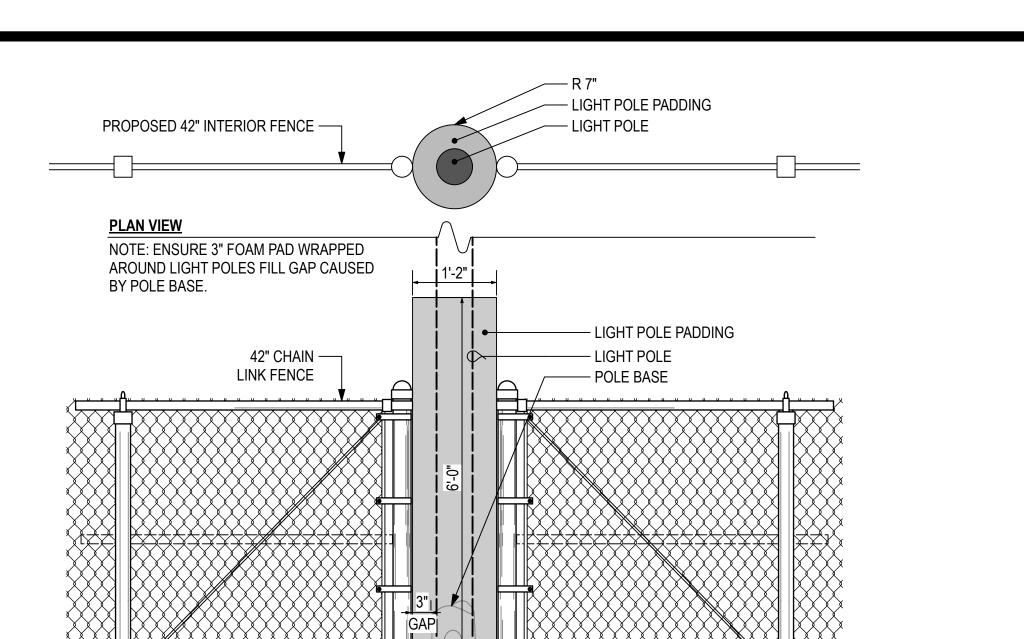

4 LIGHT POST PADDING

IMAGE REFERENCE:

Tennis Bench by Sun Trends



SITE EQUIPMENT NOTES:

1. CONTRACTOR IS RESPONSIBLE FOR COORDINATING DELIVERY AND PROVIDING ALL LABOR AND EQUIPMENT NEEDED TO RECEIVE, UNLOAD, ASSEMBLE, HANDLE, AND INSTALL SITE EQUIPMENT PER MANUFACTURER'S INSTRUCTIONS.

34'-0"

NET LINE

BASE LINE

TYP. PICKLEBALL LAYOUT

— -LINE OF CLEAR ZONE — - J

10'-0"

PLAN

– LINE OF CLEAR ZONE –

10'-0"

COURT SURFACE

COMPACTED SUBGRADE

6 COURT SURFACE. TYP.


、∟1.1 / Scale: 1" = 1'-0"


1 1/2" ASPHALT WEARING COURSE

2" ASPHALT BINDER COURSE


6" DEPTH STONE BASE


- INSPECT PRODUCTS ON DELIVERY TO DETERMINE COMPLIANCE WITH THE CONTRACT DOCUMENTS AND TO DETERMINE THAT PRODUCTS ARE UNDAMAGED AND PROPERLY PROTECTED. CONTRACTOR IS RESPONSIBLE FOR DOCUMENTING, REPORTING, AND/OR REJECTING DAMAGED EQUIPMENT TO THE MANUFACTURER'S SATISFICATION TO ENSURE TIMELY REPAIR/REPLACEMENT AT NO COST TO THE OWNER.
- CONTRACTOR IS RESPONSIBLE TO PROTECT ALL EQUIPMENT FROM ANY/ALL DAMAGE, SOILING AND DETERIORATION FROM RECEIPT OF DELIVERY UNTIL SUBSTANTIAL COMPLETION. COMPLY WITH PRODUCT MANUFACTURER'S WRITTEN INSTRUCTION FOR TEMPERATURE, HUMIDITY, VENTILATION, AND WEATHER-PROTECTION REQUIREMENTS FOR
- 4. CONTRACTOR IS RESPONSIBLE TO REMEDY ALL DAMAGE TO EQUIPMENT PROVIDED UNDER THIS CONTRACT THROUGH REPLACEMENT OR REPAIR TO THE OWNER'S SATISFACTION AT NO COST TO THE OWNER.
- 5. NOMINAL TOUCH-UP OR REPAIR OF PAINTED FINISHES IS PERMITTED IF (A) DONE IN ACCORDANCE WITH MANUFACTURER'S RECOMMENDED PROCEDURES AND MATERIALS (B) WILL NOT VOID ANY MANUFACTURER WARRANTY. THE RESULTANT REPAIRS SHALL APPEAR TO BE AS LIKE NEW CONDITION AS APPROVED BY THE LANDSCAPE ARCHITECT/OWNER IN ACCEPTANCE OF THE WORK AT NO COST TO THE OWNER.

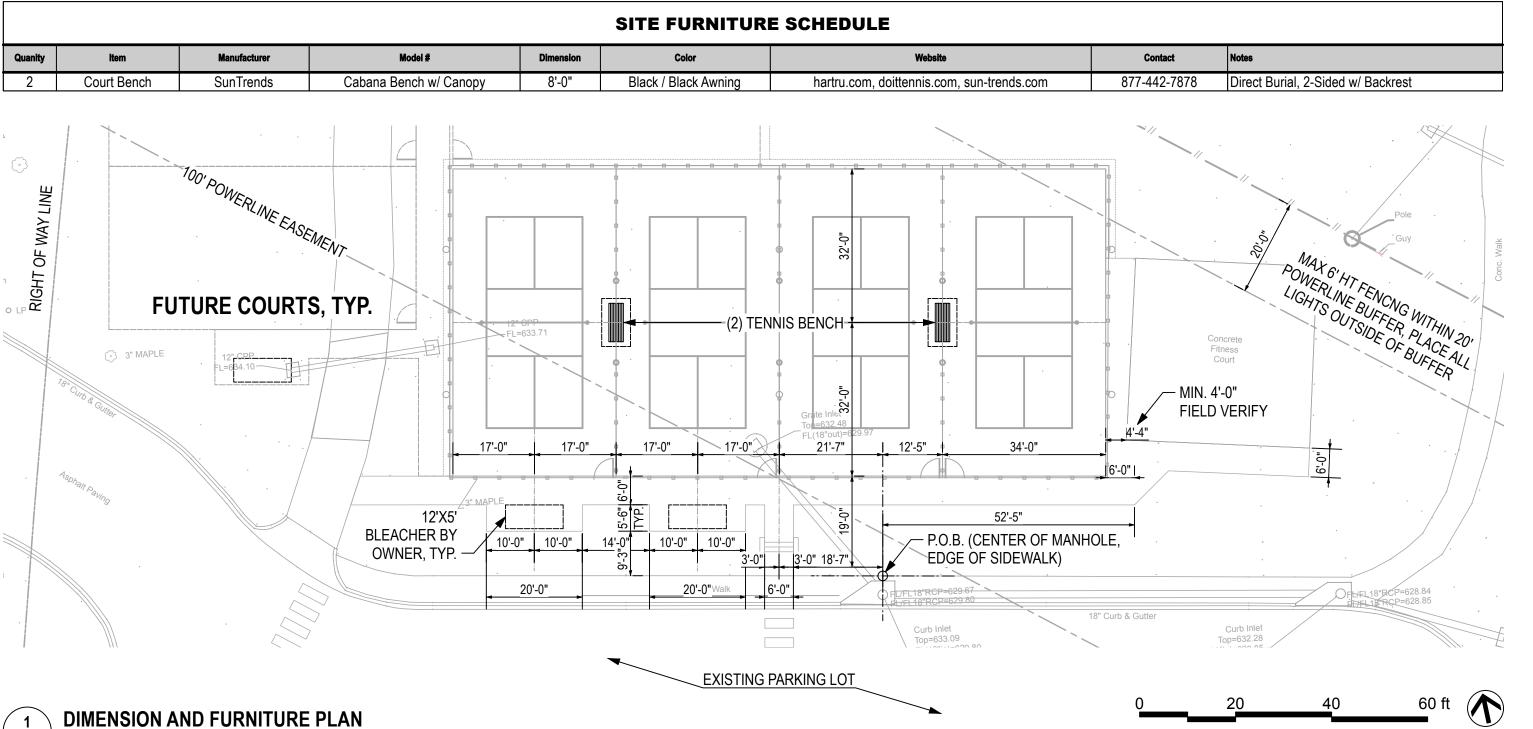


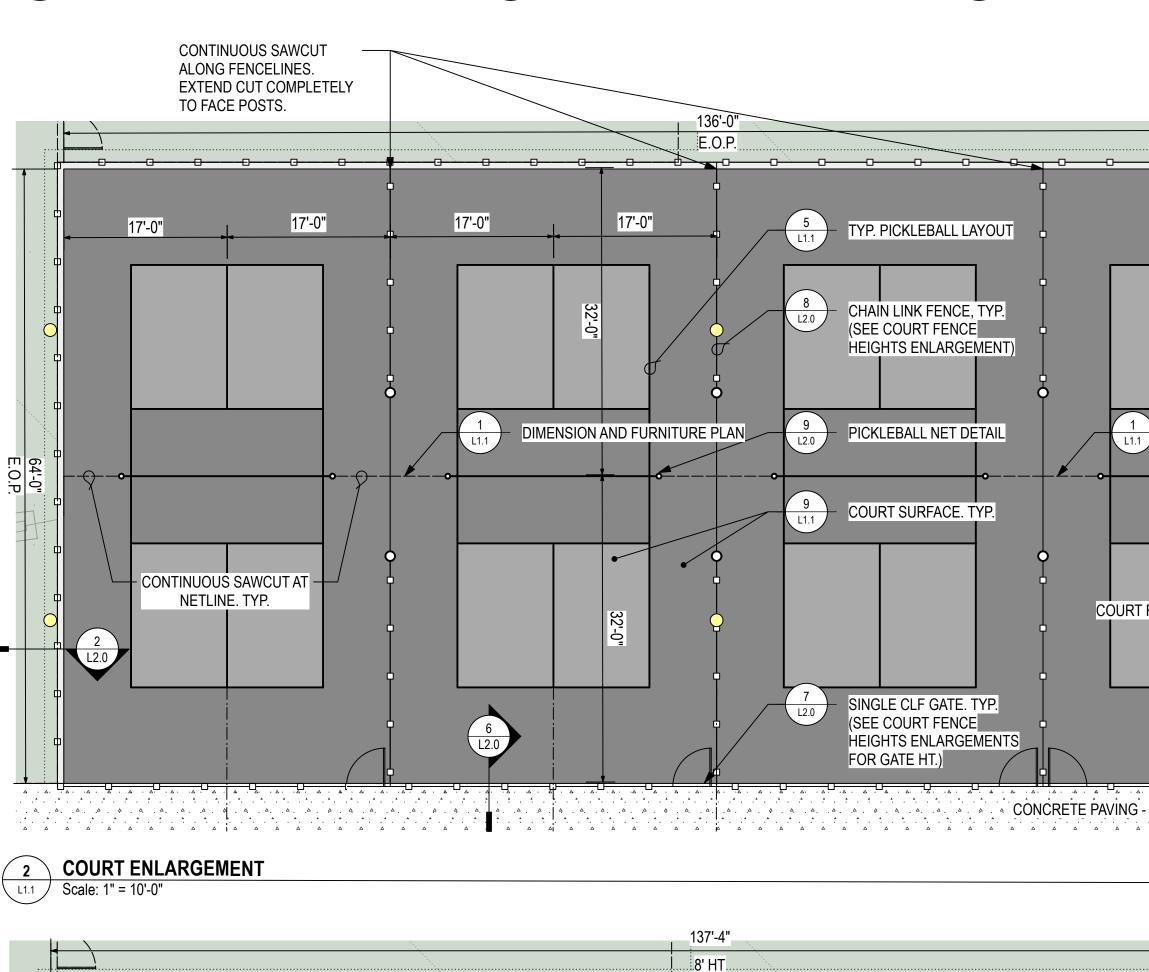


4'-0" | 30'-1" | 30'-1" | 30'-1" | 30'-0" | 30'-0" | 30'-0 3 COURT FENCE HEIGHTS L1.1 Scale: 1" = 10'-0"

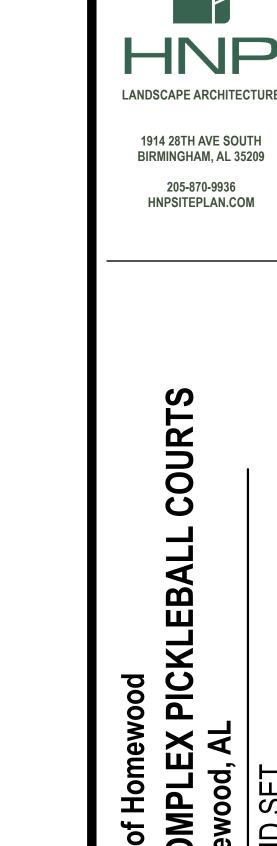

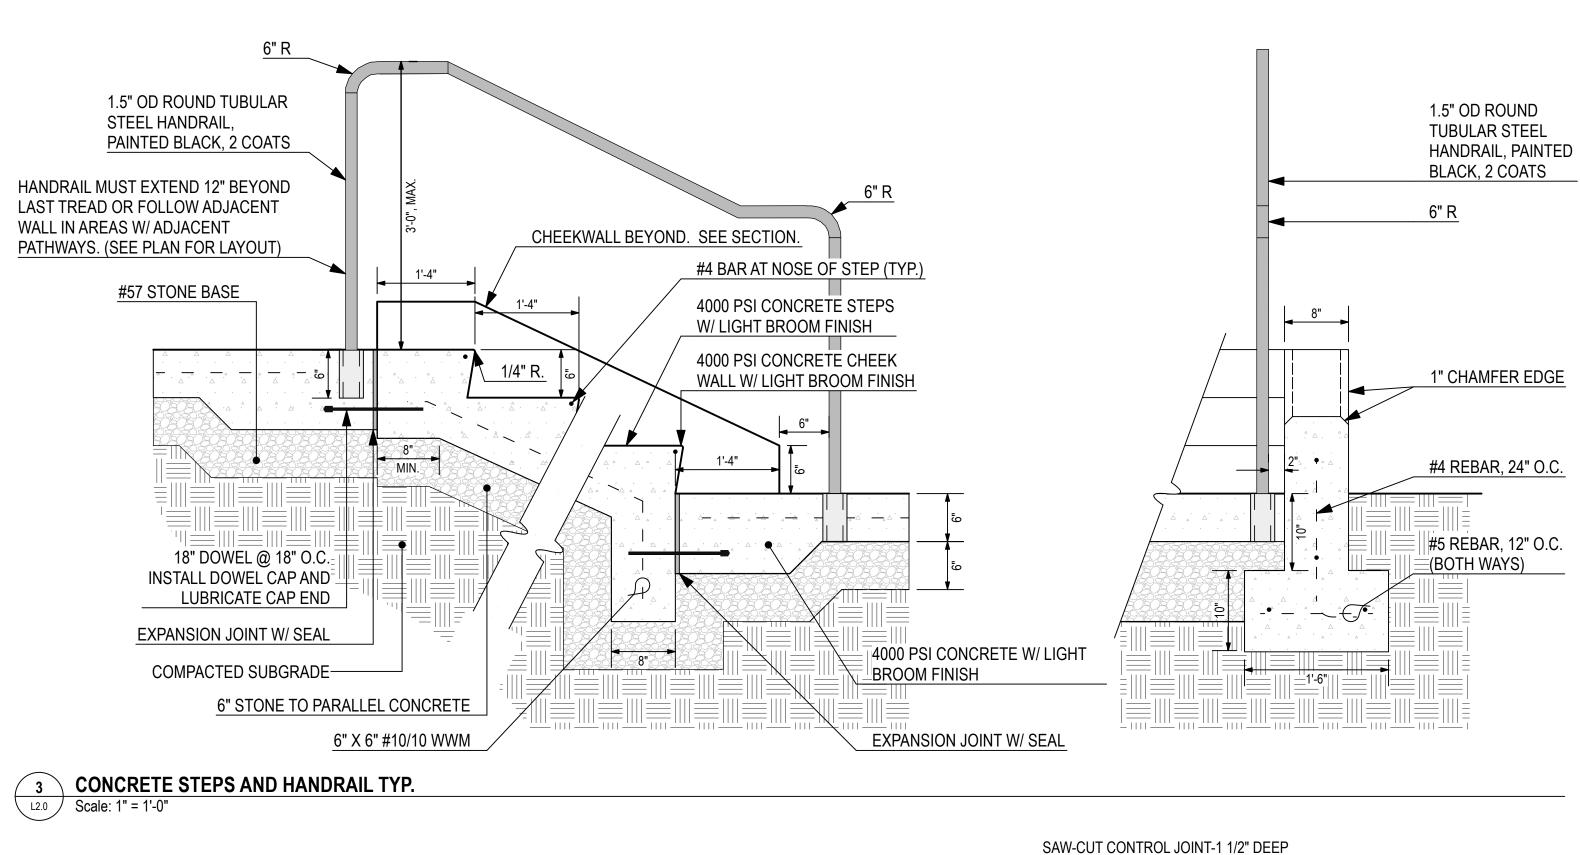


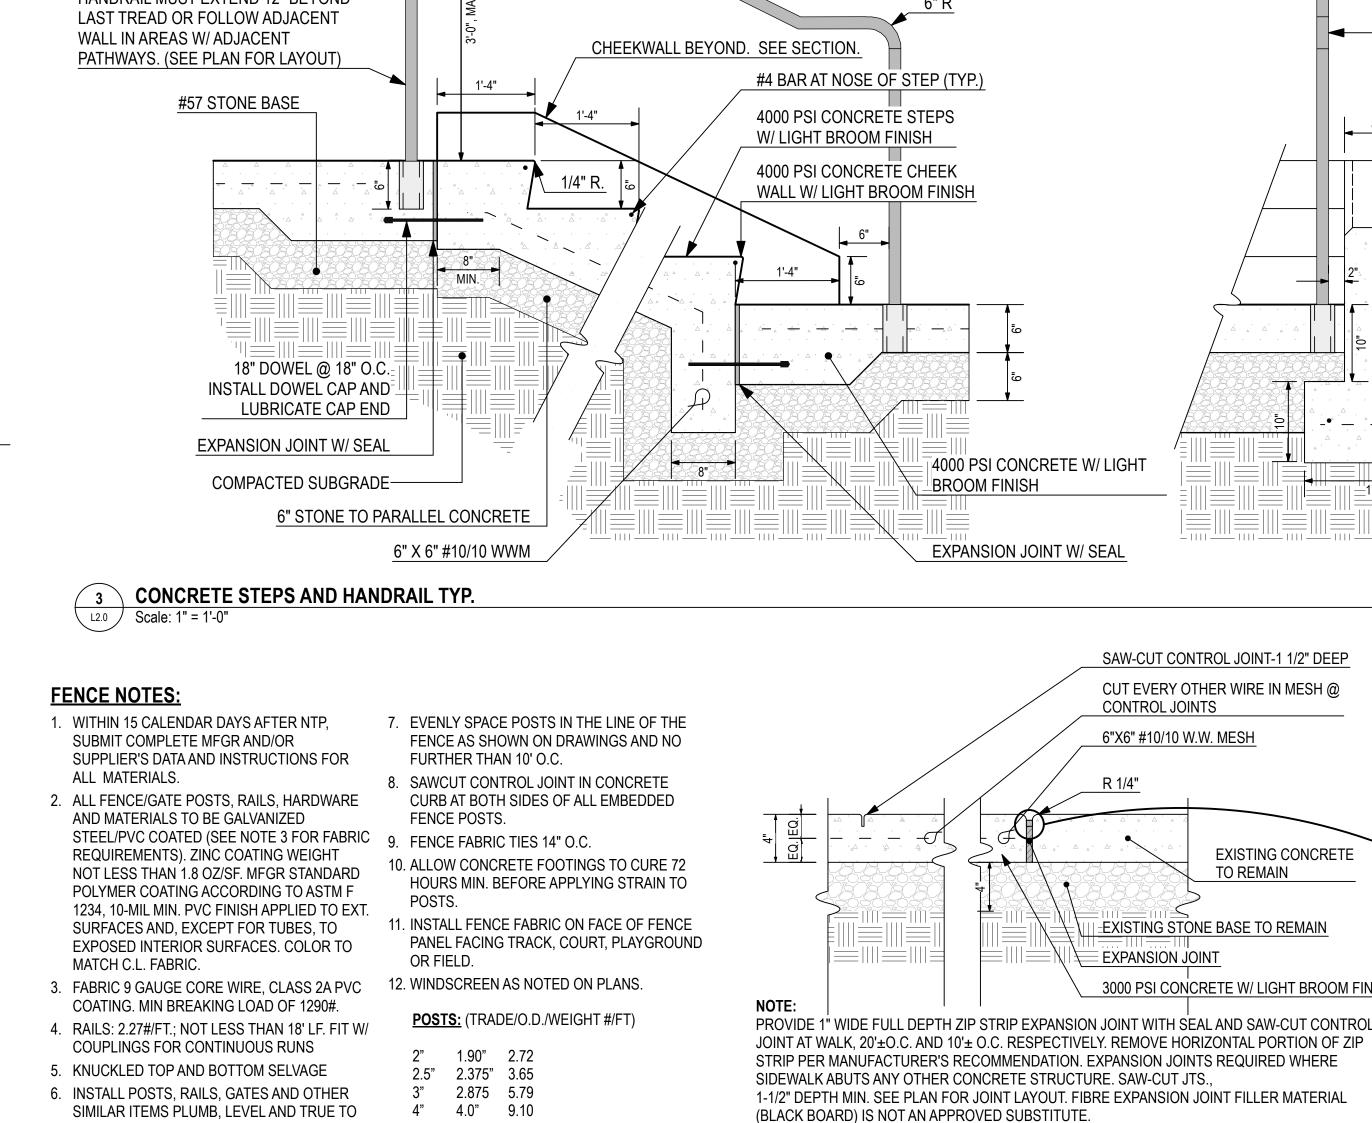

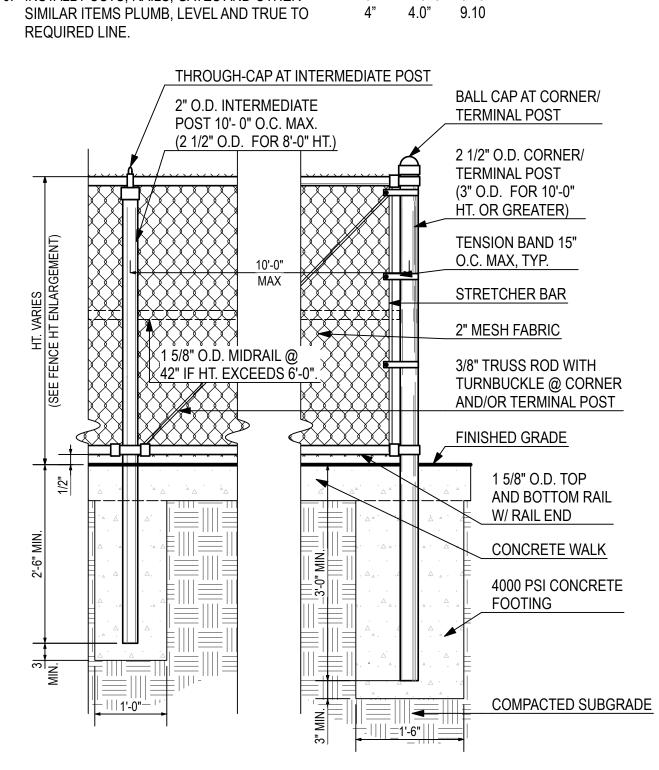

CHAIN LINK FENCE, TYP.

L2.0 Scale: 3/4" = 1'-0"

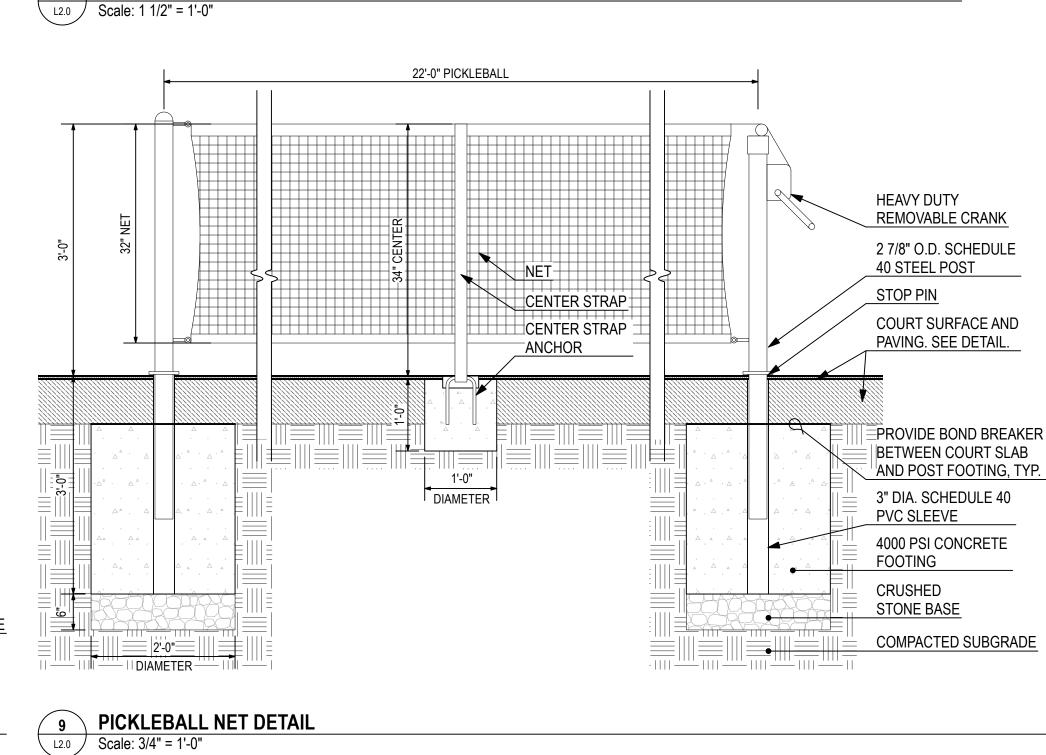

CUT EVERY OTHER WIRE IN MESH @

EXISTING CONCRETE

TO REMAIN

3000 PSI CONCRETE W/ LIGHT BROOM FINISH


EXISTING STONE BASE TO REMAIN

CONTROL JOINTS

EXPANSION JOINT

CONCRETE PAVING - 4" CONCRETE

6"X6" #10/10 W.W. MESH

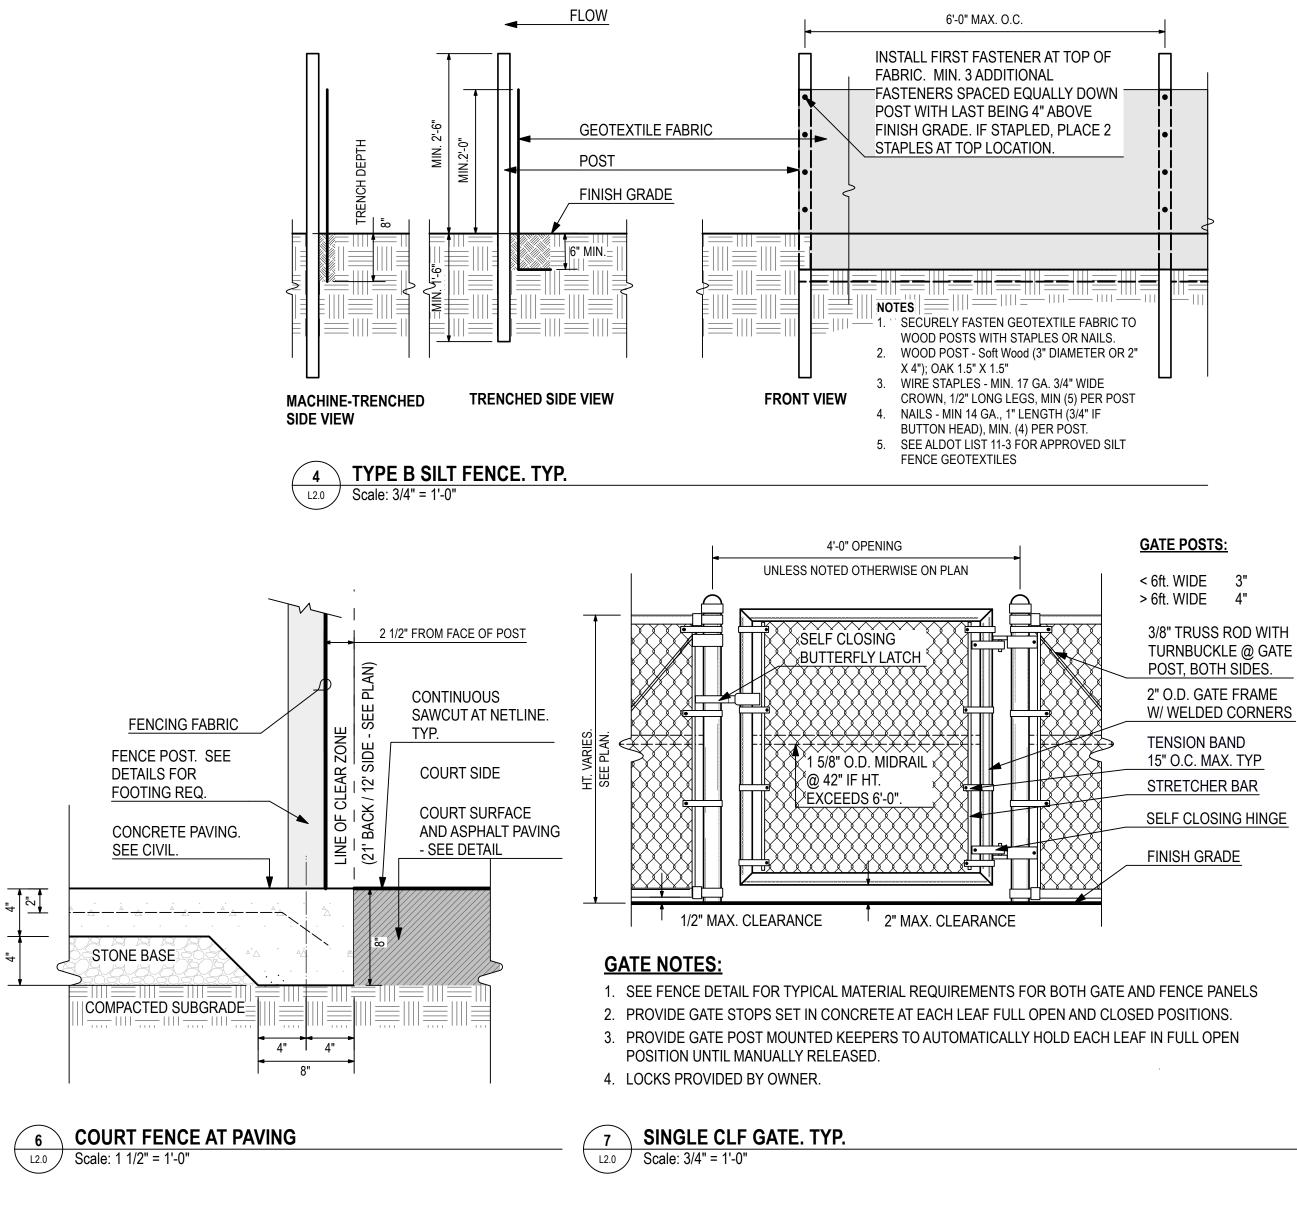

1 1/2" ASPHALT WEARING COURSE

SILT FENCE ROLL 1

ROLL JOINT TO JOINT TWO

ADJACENT FENCE SECTIONS

2" ASPHALT BINDER COURSE

6" DEPTH DENSE GRADED

COMPACTED SUBGRADE

LIMESTONE BASE

NOTE: USE EX. STONE BASE AND SUBGRADE IF NOT DISTURBED.

1 TYPICAL ASPHALT PROFILE
L2.0 Scale: 1 1/2" = 1'-0"

ENSURE POSITIVE DRAINAGE

FENCING FABRIC

SEE DETAILS FOR

CONCRETE CURB.

= 1 1/2"=

EXISTING

GRADE

COURT FENCE

L2.0 Scale: 1 1/2" = 1'-0"

4" [|] 4"

COURT FENCE AT LANDSCAPE

FOOTING REQ.

AWAY FROM COURT, TYP.

FENCE POST.

3000 PSI

FROM FACE OF POST

CONTINUOUS

COURT SIDE

- SEE DETAIL

COMPACTED SUBGRADE

MIN. 2 OVERLAPPING

ROLLS OF FABRIC PRIOR


TO POST INSTALLATION.

SILT FENCE ROLL 2

COURT SURFACE

AND ASPHALT PAVING

SAWCUT AT NETLINE.

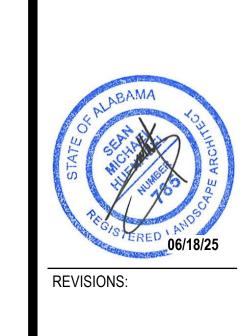

0

ISSUED: 06/18/25 BID SET

SHEET TITLE: **DETAILS**


DRAWN: WL CHECKED: SMH SHEET

2025XXX

PROJECT #: C24057

HNPSITEPLAN.COM

ó/ 1 U

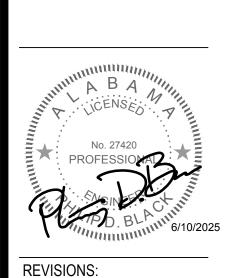

ISSUED: 6/18/25 BID SET

SHEET TITLE: **ELECTRICAL LEGEND** & NOTES

PHILIP D. BLACK, PE phil@jraee.com

JRA JOB NO. **225024**

(D) 205.536.7120

Renfro


& ASSOCIATES, INC.

ELECTRICAL ENGINEERING & DESIGN

BIRMINGHAM, ALABAMA • 35242

DRAWN: ACW | CHECKED: PDB

DCM #: 2025XXX PROJECT#: C24057

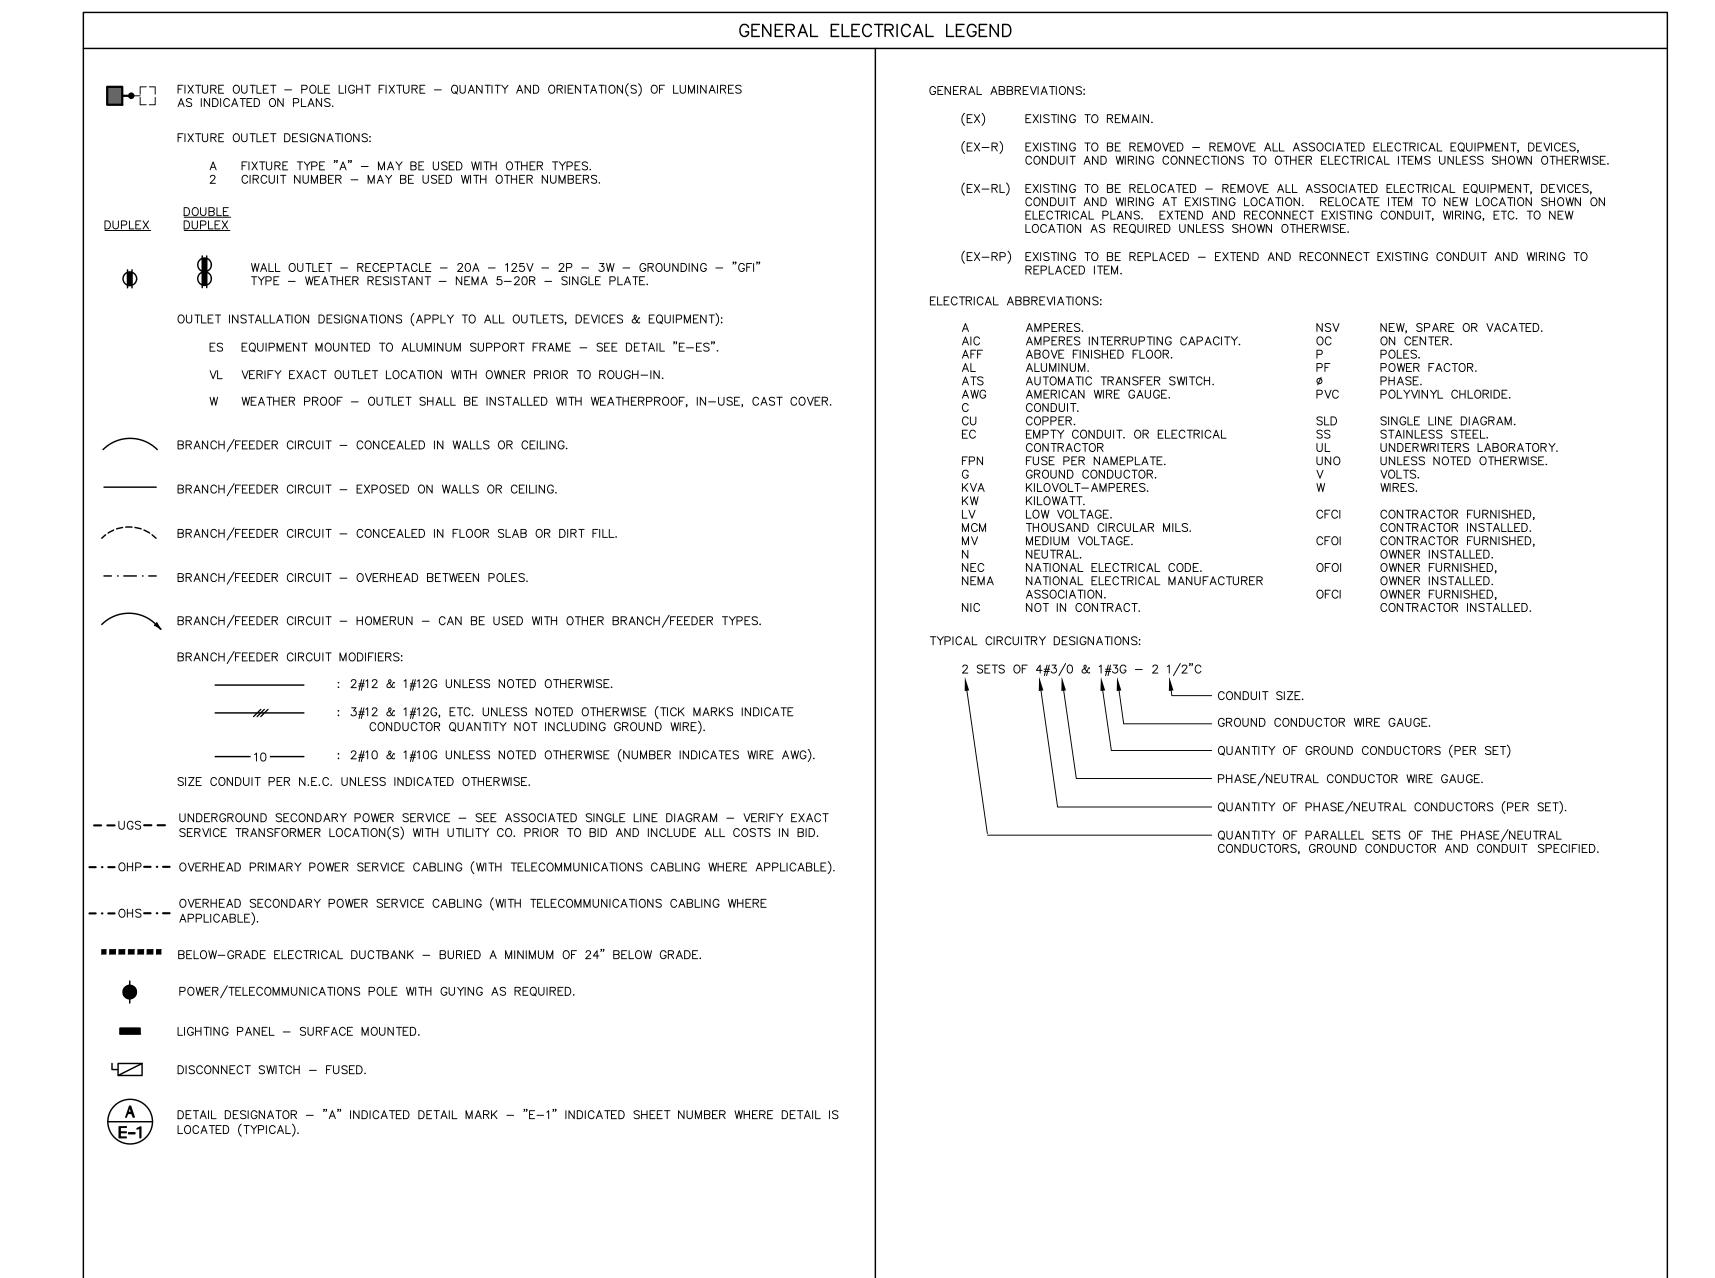

GENERAL ELECTRICAL NOTES

- 1. ALL EQUIPMENT SHALL BE GROUNDED AND BONDED IN ACCORDANCE WITH NEC.
- 2. CONTRACTOR SHALL VISIT THE SITE OF THE WORK PRIOR TO SUBMITTING BID TO EXAMINE CAREFULLY LOCAL CONDITIONS AND DIFFICULTIES TO BE ENCOUNTERED. ANY DISCREPANCY BETWEEN PLANS AND EXISTING CONDITIONS SHALL IMMEDIATELY BE CALLED TO THE ATTENTION OF THE LANDSCAPE ARCHITECT.
- 3. CONTRACTOR SHALL VERIFY ALL REQUIREMENTS FOR POWER SERVICE WITH UTILITY COMPANY PRIOR TO SUBMITTING BID. IF THEIR REQUIREMENTS ARE AT A VARIANCE WITH THOSE SHOWN ON PLANS THE CONTRACTOR SHALL INFORM LANDSCAPE ARCHITECT IMMEDIATELY. ALL COSTS INCURRED WITH THE UTILITY COMPANY FOR SERVICE SHALL BE INCLUDED IN BID PRICE. IF SUCH COSTS ARE NOT AVAILABLE AT BID TIME CONTRACTOR SHALL INCLUDE WITH BID A LETTER FROM A RESPONSIBLE PARTY WITH THE UTILITY COMPANY STATING SUCH, AND COSTS WILL THEN BE EXCLUDED FROM THE BID PRICE.

1914 28TH AVE SOUTH BIRMINGHAM, AL 35209 205-870-9936 HNPSITEPLAN.COM

ISSUED:

6/18/25 BID SET

REVISIONS:

SHEET TITLE: **ELECTRICAL DIAGRAMS, DETAILS & SCHEDULES**

DRAWN: ACW | CHECKED: PDB SHEET

Fixture Qty Contactor ID 2.59 kW 2.59 kW

LIGHTING FIXTURE SCHEDULE MANUFACTURER CATALOG MOUNTING MOUNTING WATTS LUMENS TYPE NUMBER HEIGHT MOUNT TO 26' ROUND, STRAIGHT (* REPRESENT ALUMINUM POLE WITH ONE-PIECE (QUANTITY PER POLE AS SHOWN POLE NUMBER) SPUN ALUMINUM COLLAR-TYPE ON PLANS) ANCHOR BOLT/BASE COVER WITH ROUNDED EDGES - SEE DETAIL "E-LP2"

SPORTS COURT LIGHTING FIXTURE SCHEDULE & ZONE SUMMARY

Load

LIGHTING FIXTURE SCHEDULE KEYED NOTES:

PROVIDE FINISH AS SELECTED BY LANDSCAPE ARCHITECT.

SCHEDULE NOTES:

Zone Summary

1. ALL CONTACTORS SHALL BE 30A-2P, FURNISHED IN A COMMON CABINET & CONTROLLED BY SPORTS FIELD LIGHTING SUPPLIER.


Description

Courts 1-2

Courts 3-4

			PANELBO	ARD S	SCHE	DULE	- RP-PKBL			
P/	PANEL TYPE: SQUARE 'D' TYPE NQ		SQUARE 'D' TYPE NQ	AIC RATING:		ating:	22KAIC (MINIMUM)			
V	VOLTAGE 120/240V-1P-3W			MOUNTING:		SURFACE				
AN	AMPS & TYPE: 100 AMP - MLO				LOCATION: EQUIPMENT STAND					
FE	FED FROM: MAIN FU		MAIN FUSED DISCONNECT SWITCH		FEEDER:		SEE SINGLE LINE DIAGRAM			
CK	r. NOTES	BKR	DESCRIPTION	WATTS	PHASE	WATTS	DESCRIPTION	BKR	NOTES	СКТ
NO										NO.
1	LCC	30/2	PICKLEBALL LIGHTS	1,295	Α			20/1	-	13
2	LCC		I	1,295	В			20/1	-	14
3	LCC	30/2	PICKLEBALL LIGHTS	1,295	Α			20/1	-	15
4	LCC		I	1,295	В			20/1	-	16
5	-	30/2	SPARE		Α			20/1	-	17
6	-	- 1	1		В			20/1	-	18
7	-	30/2	SPARE		Α			20/1	-	19
8	-	-	I		В			20/1	-	20
9	-	20/1	SPARE		Α			20/1	-	21
10	-	20/1	SPARE		В			20/1	-	22
11	-	20/1	CONV. RECEP	200	Α			20/1	-	23
12	-	20/1	SPORTS LTG CONTROL CABINET	100	В			20/1	-	24
NOTES:				PH. A:	PH. B:		TOTAL CONNECTED LOAD		5.5 KVA	
1.	1. ENCLOSURE SHALL BE NEMA 3R LOCKABLE.				2,690				23.8	AMPS
2.	2. PROVIDE INTEGRAL 160KA (PER PHASE) SURGE						TOTAL DEMAND	LOAD:	5.5	KVA
PROTECTION DEVICE.								23.8	AMPS	
						TOTAL COMPUTED	LOAD:	6.8	KVA	
								29.6	AMPS	


PANELBOARD/EQUIPMENT SCHEDULE(S) KEYED NOTES LEGEND <u>DESCRIPTION</u> INDICATED CIRCUIT SHALL BE ROUTED THRU LIGHTING CONTACTOR - SEE PLANS & SINGLE LINE DIAGRAM.

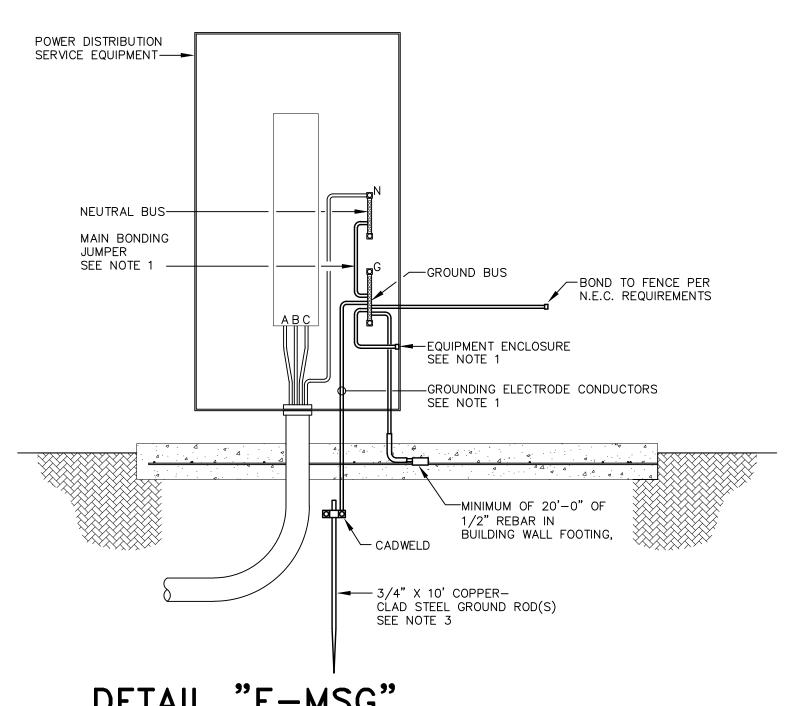

DETAIL "E-MSG" MAIN SERVICE GROUNDING

DETAIL NOTES

- ALL GROUNDING ELECTRODE CONDUCTORS AND MAIN BONDING JUMPERS SHALL BE INSULATED COPPER, SIZED IN ACCORDANCE WITH NEC TABLE 250.66 UNLESS NOTED
- THE INTERSYSTEM BONDING JUMPER SHALL BE INSULATED COPPER, SIZED TO MATCH THE GROUNDING ELECTRODE CONDUCTOR OR #6AWG, WHICHEVER IS GREATER.
- ADDITIONAL GROUND RODS SHALL BE INSTALLED A MINIMUM OF SIX (6) FEET APART AND CONNECTED BY GROUNDING ELECTRODE CONDUCTORS UNTIL THE GROUND RESISTANCE DOES NOT EXCEED FIVE (5) OHMS.
- ALL GROUNDING CONDUCTORS SHALL BE INSTALLED IN CONDUIT (TYPE PER SPECIFICATION REQUIREMENTS) UNLESS SPECIFICALLY NOTED OTHERWISE. METAL CONDUITS SHALL BE GROUNDED PER NEC REQUIREMENTS.
- REFER TO "GROUNDING" SPECIFICATIONS SECTION FOR ADDITIONAL GROUNDING REQUIREMENTS.

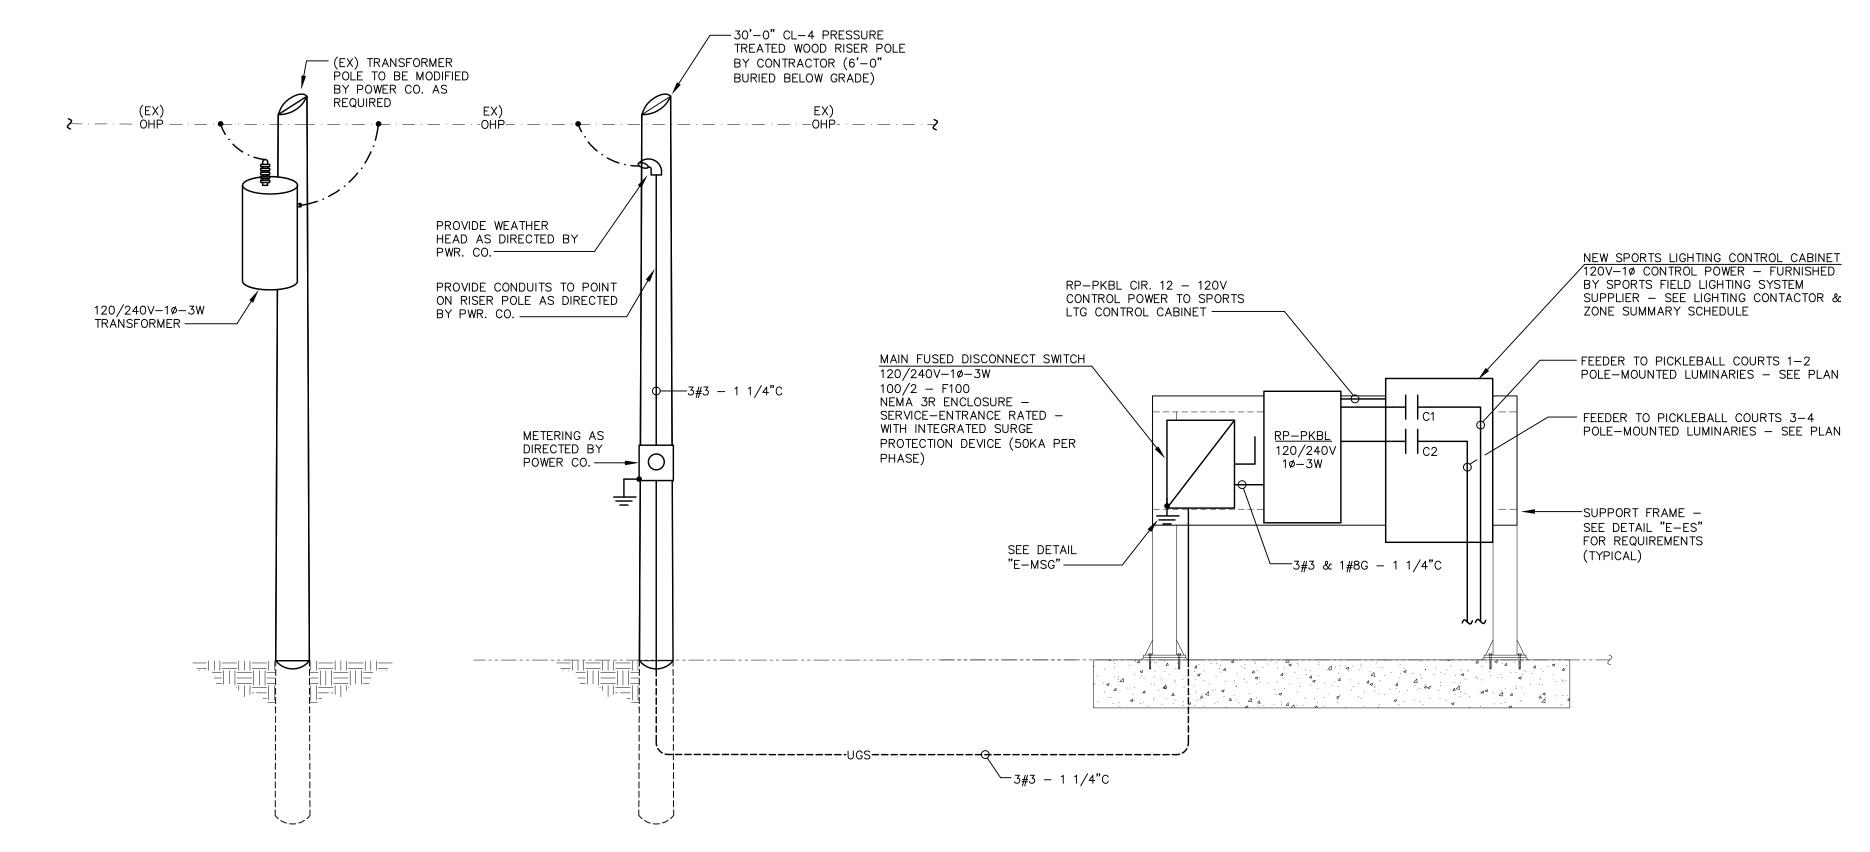

SINGLE LINE DIAGRAM

DIAGRAM NOTES

- REFER TO PANELBOARD SCHEDULES FOR ALL APPLICABLE FEEDER SIZES, BREAKER RATINGS, BUS RATINGS, ETC. NOT SHOWN ON THIS DIAGRAM.
- 2. NEW NEUTRAL-GROUND BONDS SHALL ONLY BE MADE AT THE FOLLOWING LOCATIONS: A. MAIN FUSED DISCONNECT SWITCH.

PHILIP D. BLACK, PE JACKSON, Renfro (D) 205.536.7120 (P) 205.995.1078 & ASSOCIATES, INC. JRA JOB NO. **225024** ELECTRICAL ENGINEERING & DESIGN 31 INVERNESS CENTER PKWY • SUITE 301 BIRMINGHAM. ALABAMA • 35242

phil@jraee.com


DCM #: 2025XXX PROJECT #: C24057

SHEET TITLE:

DRAWN: ACW | CHECKED: PDB SHEET

DCM #: 2025XXX

PROJECT #: C24057

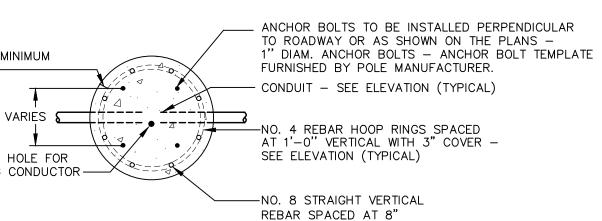

HORIZONTAL WITH 3" COVER


PLAN VIEW

3" CLEAR MINIMUM

1/2" WEEP HOLE FOR

GROUNDING CONDUCTOR -

(TYPICAL)—

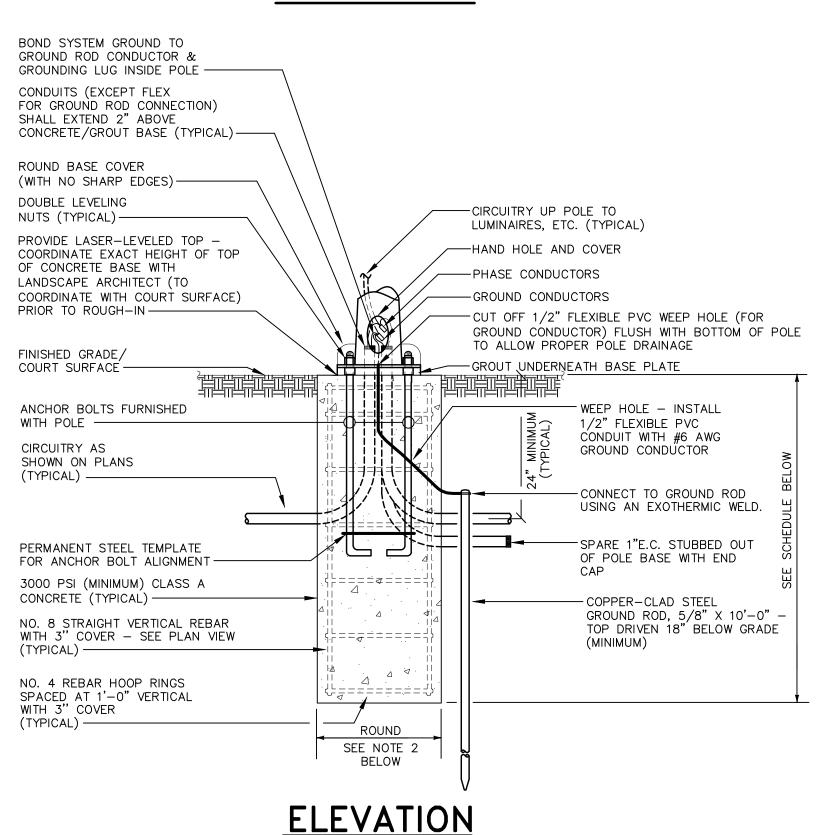

DETAIL "E-LP2" FLUSH-WITH-GRADE LIGHT POLE BASE

DETAIL NOTES


THIS CONTRACTOR SHALL CONFIRM SOIL CONDITIONS PRIOR TO BID OR INSTALLATION. IF SOIL CONDITIONS/TYPES ARE DIFFERENT THAN THE SPECIFIC TYPES INDICATED BELOW, OR THE POLE HEIGHTS ARE IN EXCESS OF THOSE LISTED BELOW, OR THE BASIC WIND SPEED FOR THE PROPOSED POLE LOCATION (PER ASCE 7 BASIC WIND SPEED MAPS) IS IN EXCESS OF 100MP, OR THE COMBINED E.P.A. OF ALL LUMINAIRES/ARMS/ACCESSORIES INSTALLED ON A POLE IS IN EXCESS OF 5.5 S.F., THE CONTRACTOR SHALL RETAIN A QUALIFIED STRUCTURAL ENGINEER (LICENCED IN THE STATE OF THE PROJECT) TO PROVIDE A PROJECT-SPECIFIC STRUCTURAL DESIGN FOR THE PROPOSED POLE BASE(S), AND SHALL INCLUDE ALL COSTS (FOR THE DESIGN AND THE REQUIRED POLE BASES) IN THE BID.

- 2. MINIMUM POLE BASE DIAMETER SHALL BE THE GREATER OF THE FOLLOWING: A. ANCHOR BOLT CIRCLE DIAMETER PLUS 8" (TO PROVIDE MINIMUM 4" COVER OVER ALL ANCHOR BOLTS).
 - B. 20" DIAMETER. C. DIAMETER AS REQUIRED BY SOIL CONDITIONS OR BY POLE SUPPLIER.

FACTOR WITH ALL LUMINAIRES & ACCESSORIES INSTALLED.

- 3. CONTRACTOR SHALL VERIFY LOCATIONS OF ALL UNDERGROUND UTILITIES OR OBSTRUCTIONS TO
- AVOID CONFLICTS PRIOR TO INSTALLATION OF LIGHT POLE BASE(S). 4. POLE SHALL BE RATED TO WITHSTAND THE WIND SPEED SPECIFIED FOR THE SPECIFIC PROJECT SITE LOCATION PER LATEST VERSION OF ASCE 7 BASIC WIND SPEED MAPS OR APPLICABLE LOCAL BUILDING CODE REQUIREMENTS (WHICHEVER IS MORE STRINGENT), WITH 1.3 GUST

	POLE BASE DIMENSIONS							
POLE HEIGHT	MININ (BASE DIAMETER						
	CLAYEY SOILS (CL, ML, CH, MH)	SANDY SOILS (SW, SP, SM, SC, GM, GC)	GRAVELY SOILS (GW, GP)					
0 - 15 FT. 16 - 20 FT. 21 - 25 FT. 26 - 30 FT. 31 - 35 FT. 36 - 40 FT. 41 - 45 FT. 46 - 50 FT.	5'-6" 6'-6" 7'-6" 8'-0" 8'-6" 9'-6" 10'-0"	4'-6'' 5'-0'' 5'-6'' 6'-6'' 7'-0'' 7'-6'' 8'-0'' 8'-6''	4'-0'' 4'-6'' 5'-0'' 6'-0'' 6'-6'' 7'-0'' 7'-6'' 8'-0''	SEE NOTE 2 ABOVE				

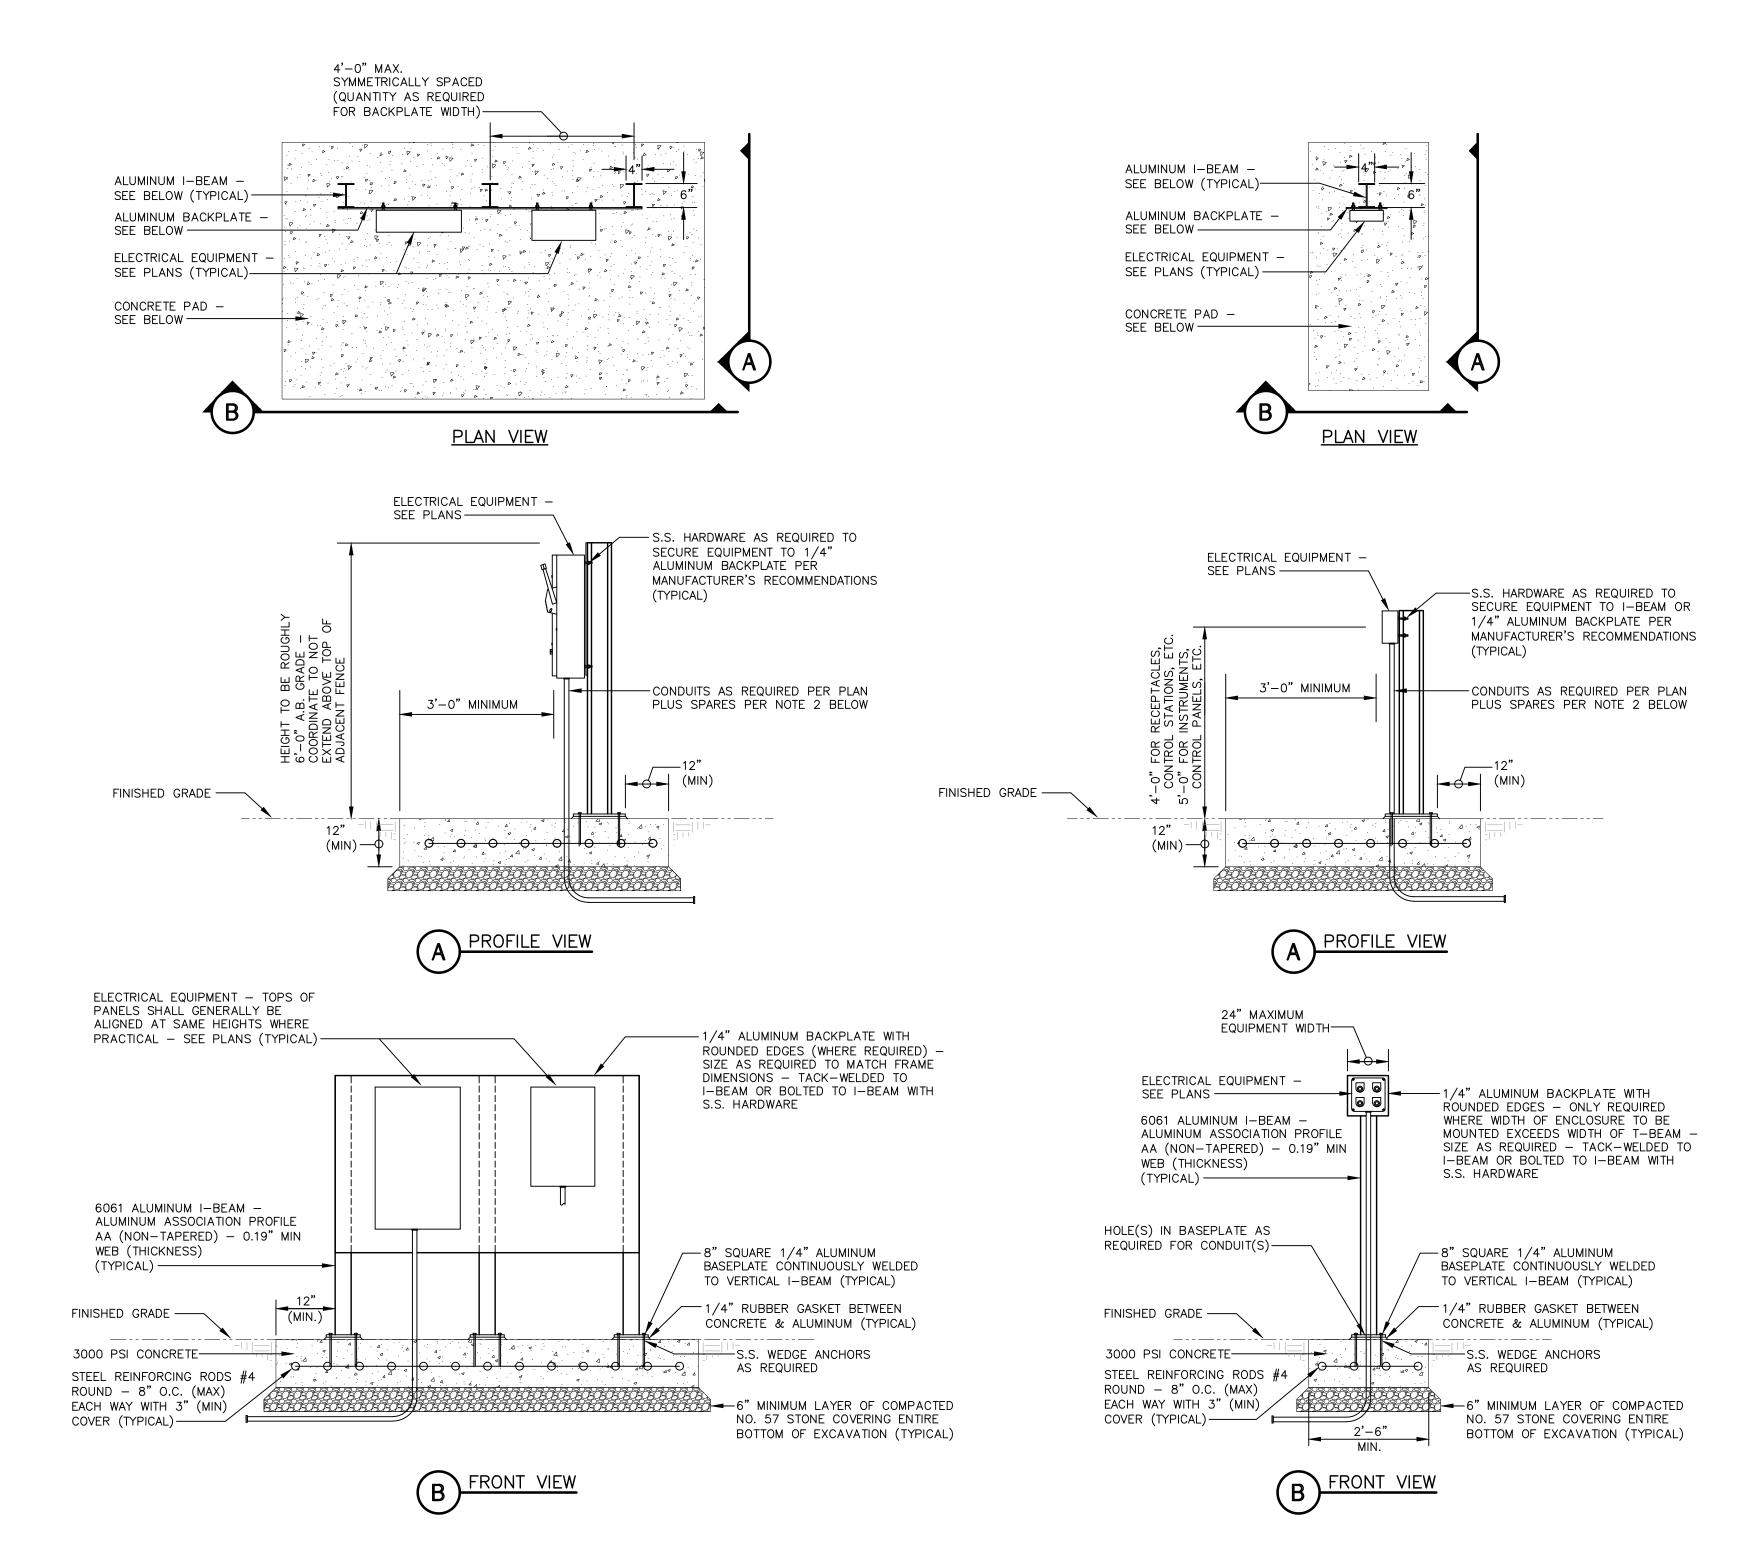

DETAIL "E-ES" **EQUIPMENT SUPPORT**

SCALE : NONE

	DETAIL NOTES
1.	ALL DIMENSIONS SHOWN ARE TYPICAL.
2.	PROVIDE TWO (2) 1"E.C. FROM ALL DISTRIBUTION PANELS, LIGHTING PANELS, PLC'S AND CONTROL PANELS ROUTED BELOW CONCRETE PAD TO NEAREST PULLBOX OR ACCESSIBLE STUB OUT LOCATION (NOT UNDERNEATH CONCRETE/ROCK/STRUCTURE/ETC).



LANDSCAPE ARCHITECTURE

1914 28TH AVE SOUTH BIRMINGHAM, AL 35209


205-870-9936 HNPSITEPLAN.COM

SHEET TITLE:
SITE ELECTRICAL
PLANS

DRAWN: ACW CHECKED: PDB

E1.0

DCM # : 2025XXX
PROJECT # : C24057

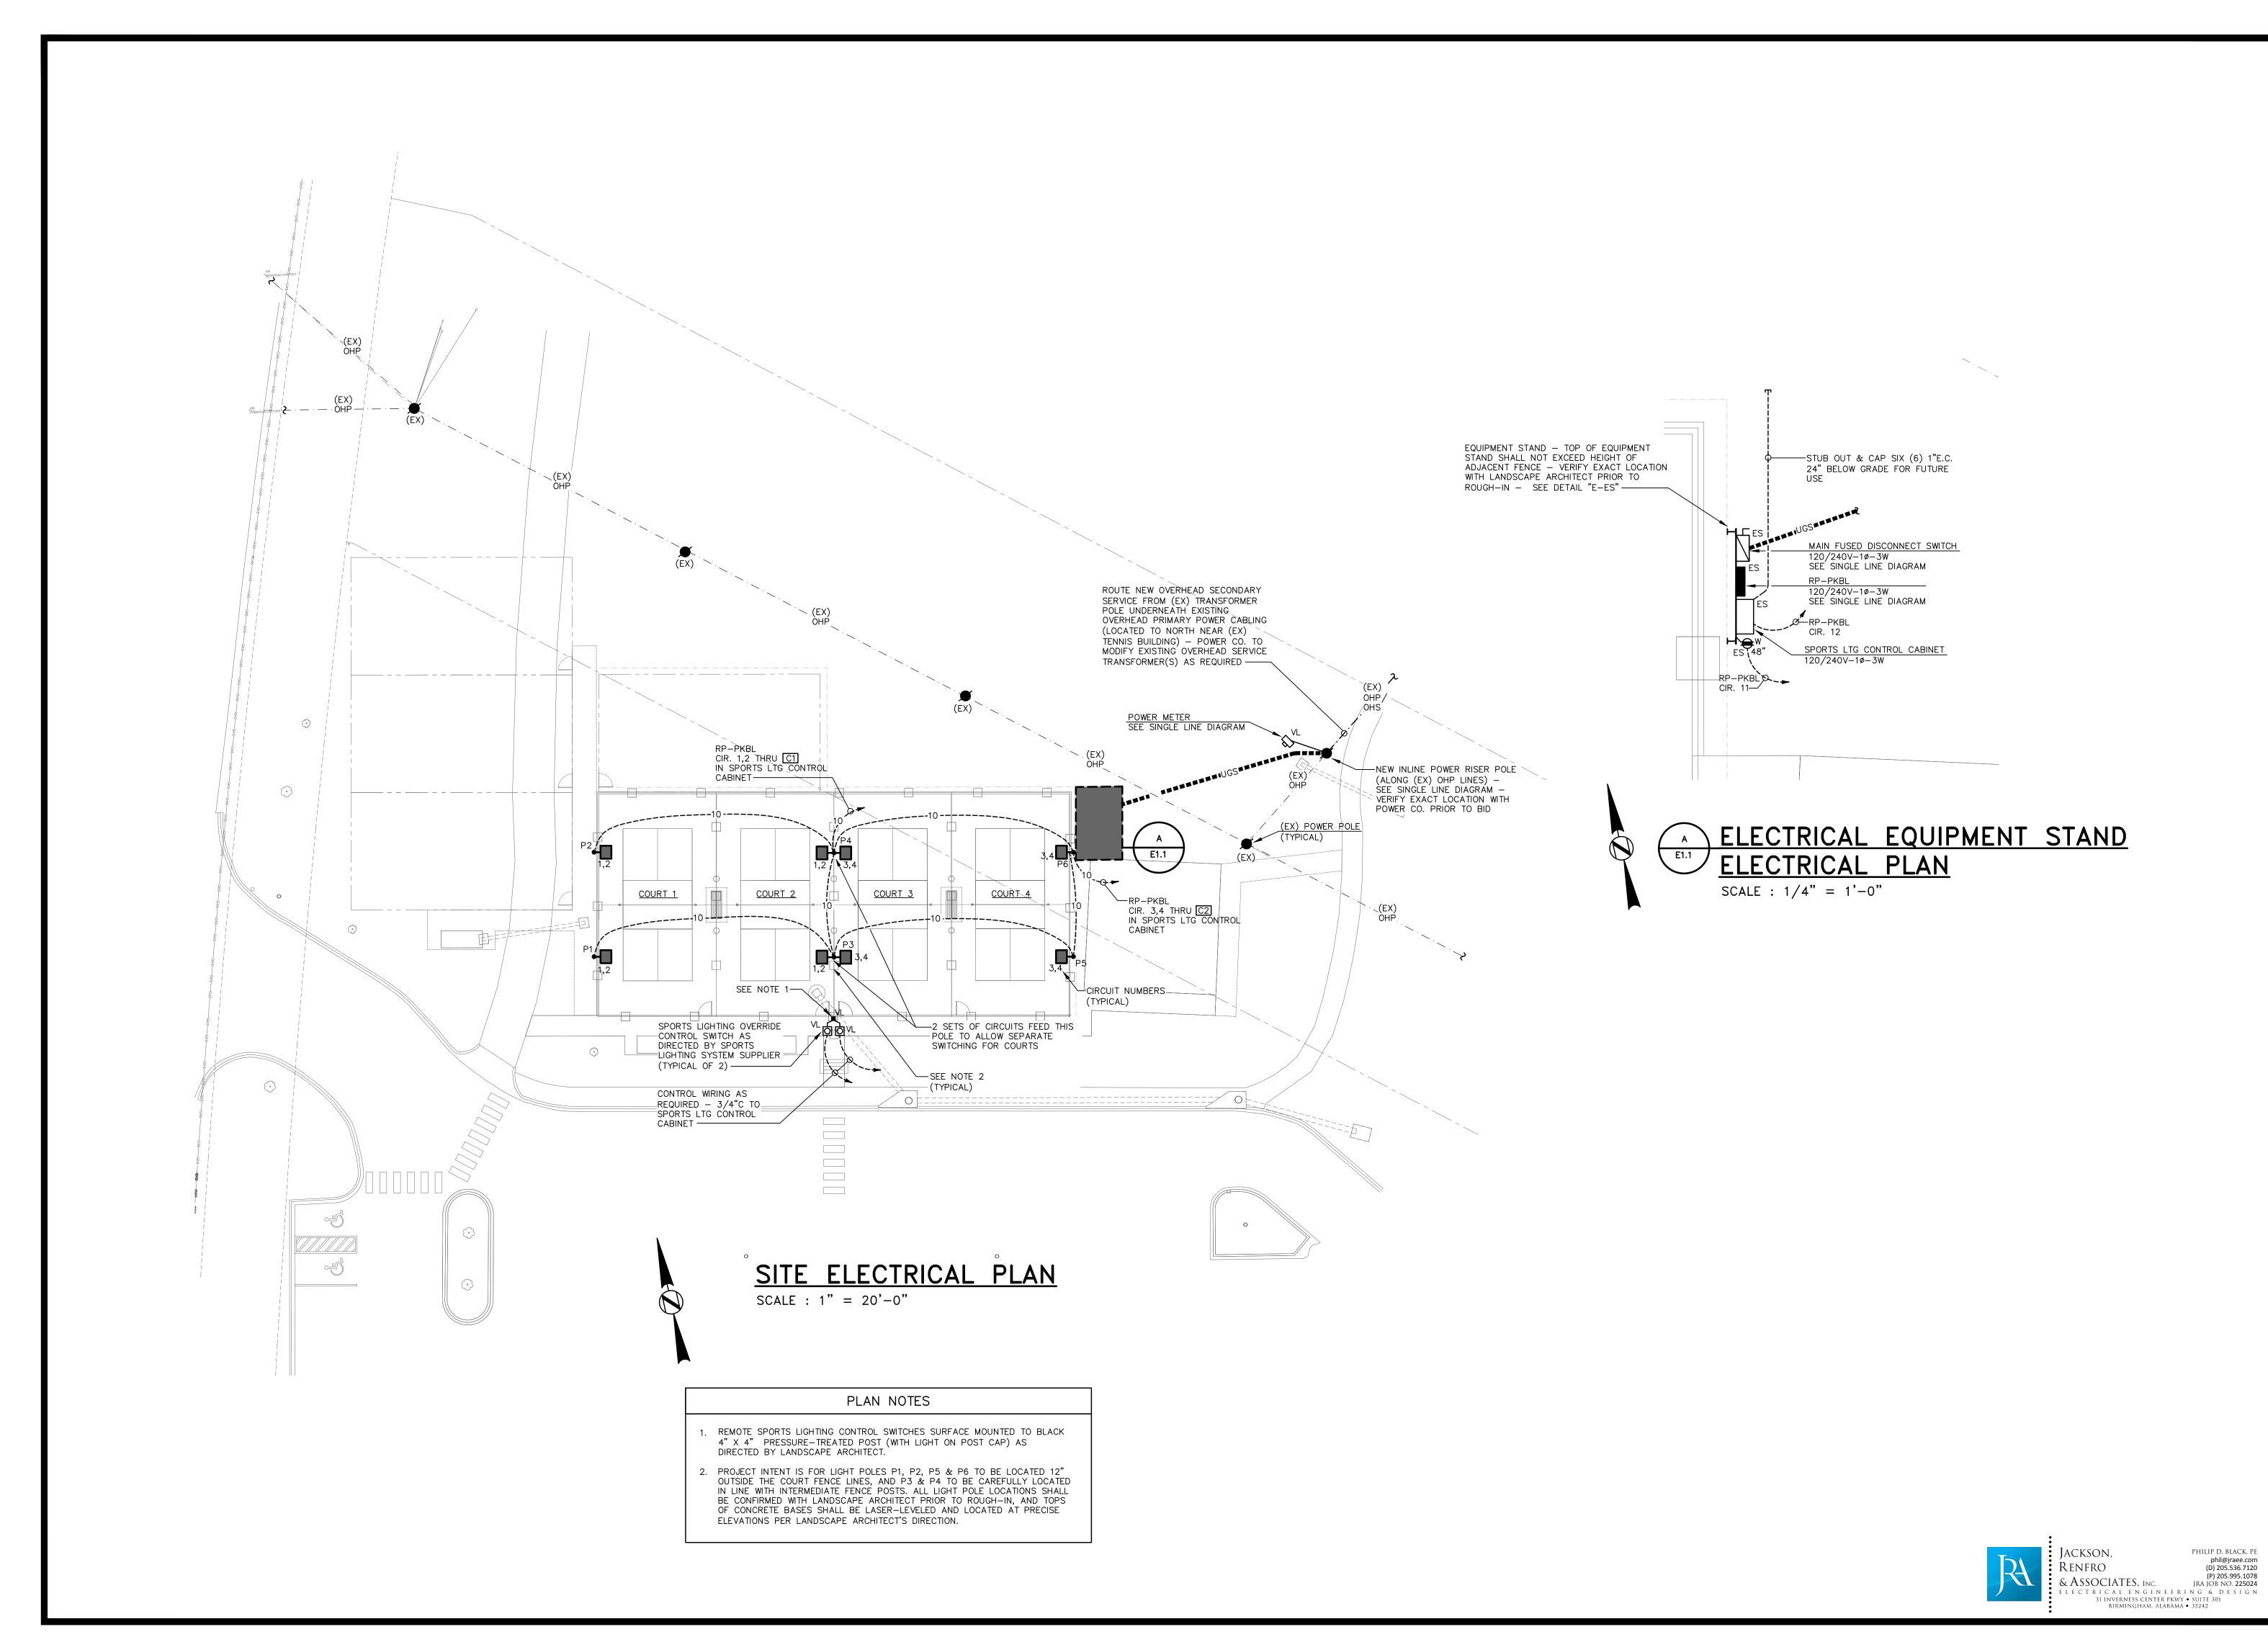



1914 28TH AVE SOUTH BIRMINGHAM, AL 35209 205-870-9936 HNPSITEPLAN.COM

The City of Homewood

Homewood Athletic Complex Pickleball Co
Homewood, AL



REVISIONS:

ISSUED: 6/18/25 BID SET

SHEET TITLE:
SITE PHOTOMETRIC
PLAN

DRAWN: ACW CHECKED: PDB
SHEET

DCM#: 2025XXX
PROJECT#: C24057